

THE ORCHARD STAGE 3 DARLING ROAD, JENSEN FOR ELEMENTS NQ PTY LTD

127 | 126 | 125 | 124 | 123 184 STAGE 3B YORKSHIRE CRESCENT SITE AREA 5.12Ha 9 LOTS 130 180 **FUTURE** STAGE 8 STAGE 3A SITE AREA 5.67Ha 33 LOTS 232

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PROJECT.


MENDI CONSTRUCTIONS PTY LTD DO HEREBY CERTIFY THAT THE WORKS

AUTHORISED DELEGATE ... DATE ..09/11/2021.....

PREMISE DO HEREBY CERTIFY THAT THE WORKS AS SHOWN ON THE 'AS CONSTRUCTED' DRAWINGS REFLECT ANY CHANGES THAT WERE MADE DURING THE COURSE OF CONSTRUCTION.

DATE .10/11/21

Revisio	Revisions			Level Datum: AHD (DERIVED)		
No.	Date	Details	Check	B.M. Used: PM200736		
Α	03.11.21	Original Issue	PAT	Coordinate Projection: Plane		
				Coordinate Datum: Arbitrary		
				Origin of Coordinates: PM200736	E:	62389.140
				Meridian:	N:	94092.020
				Map Reference:		
				Contour Interval:	Sur	veyed by: BM
				Job No: 27687-068-01	Dra	wn: MJM
				File No: 27687 129A.dwg	Apr	roved:

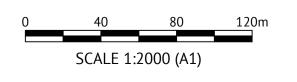

LOCALITY PLAN

LOT 1 ON RP800747 LOT 2000 ON SP289546

Client:	ELEMENTS NQ PTY LTD
Project:	
	AS CONSTRUCTED - THE ORCHARD 3A
	DARLING ROAD, JENSEN
LO	CALITY PLAN, SITE PLAN & DRAWING SCHEDULE

Locality:


Local Authority: Townsville City Council

Plan No: 27687/129 A braziermotti.com.au SURVEYING TOWNPLANNING

Date: 3 November 2021

Scale: AS SHOWN



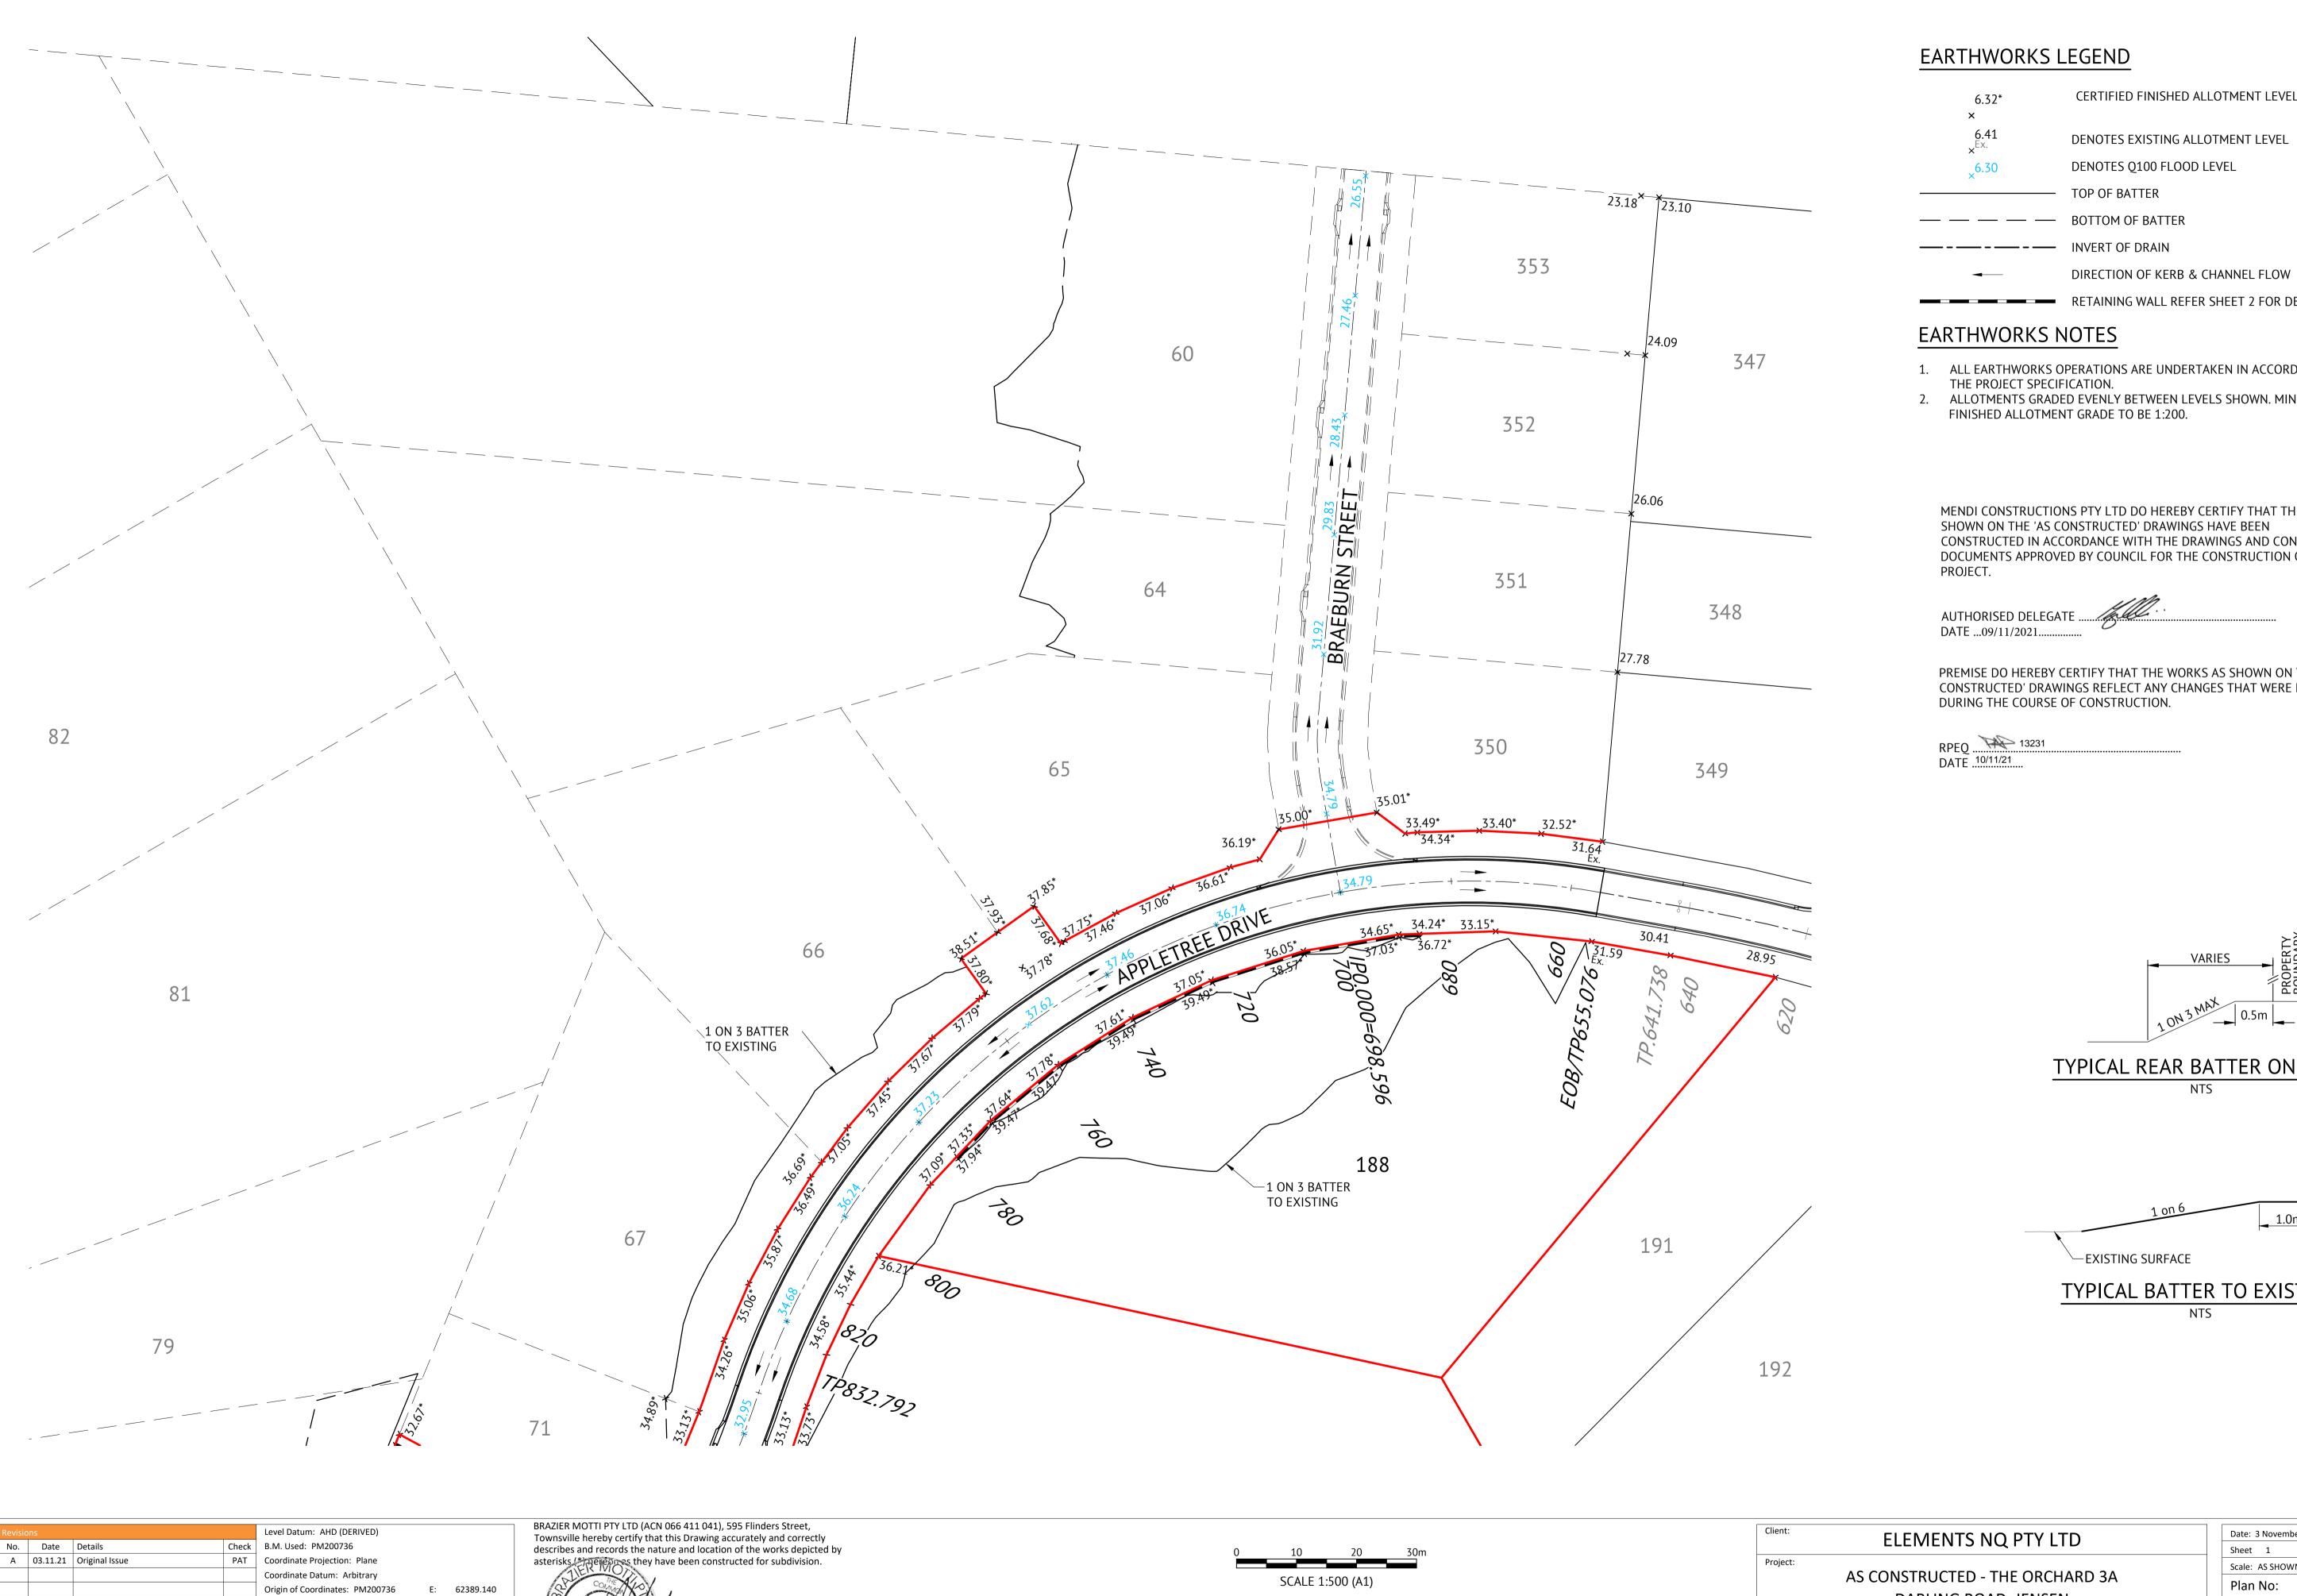

N: 94092.020

Surveyed by: BM

Drawn: MJM

Approved:

Meridian:

Map Reference:

Contour Interval:

Job No: 27687-068-01

File No: 27687_130A.dwg

CERTIFIED FINISHED ALLOTMENT LEVEL DENOTES EXISTING ALLOTMENT LEVEL DENOTES Q100 FLOOD LEVEL TOP OF BATTER


— – — INVERT OF DRAIN


RETAINING WALL REFER SHEET 2 FOR DETAILS

- 1. ALL EARTHWORKS OPERATIONS ARE UNDERTAKEN IN ACCORDANCE WITH
- 2. ALLOTMENTS GRADED EVENLY BETWEEN LEVELS SHOWN. MINIMUM

MENDI CONSTRUCTIONS PTY LTD DO HEREBY CERTIFY THAT THE WORKS SHOWN ON THE 'AS CONSTRUCTED' DRAWINGS HAVE BEEN CONSTRUCTED IN ACCORDANCE WITH THE DRAWINGS AND CONTRACT DOCUMENTS APPROVED BY COUNCIL FOR THE CONSTRUCTION OF THE

PREMISE DO HEREBY CERTIFY THAT THE WORKS AS SHOWN ON THE 'AS CONSTRUCTED' DRAWINGS REFLECT ANY CHANGES THAT WERE MADE DURING THE COURSE OF CONSTRUCTION.

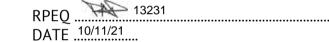

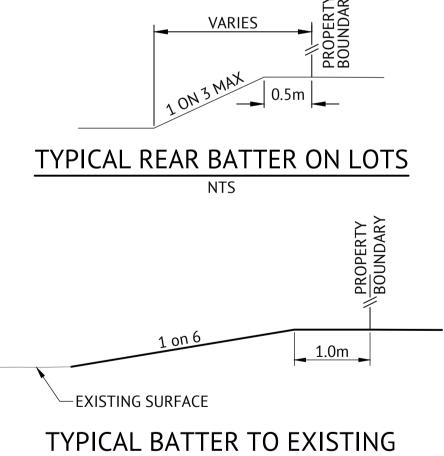


DARLING ROAD, JENSEN EARTHWORKS LAYOUT PLAN - SHEET 1 OF 3

Plan No: 27687/130 A braziermotti.com.au SURVEYING TOWNPLANNING PROJECTMANAGEMENT

Scale: AS SHOWN

Date: 3 November 2021

Local Authority: Townsville City Council Locality: MAPPING&GIS

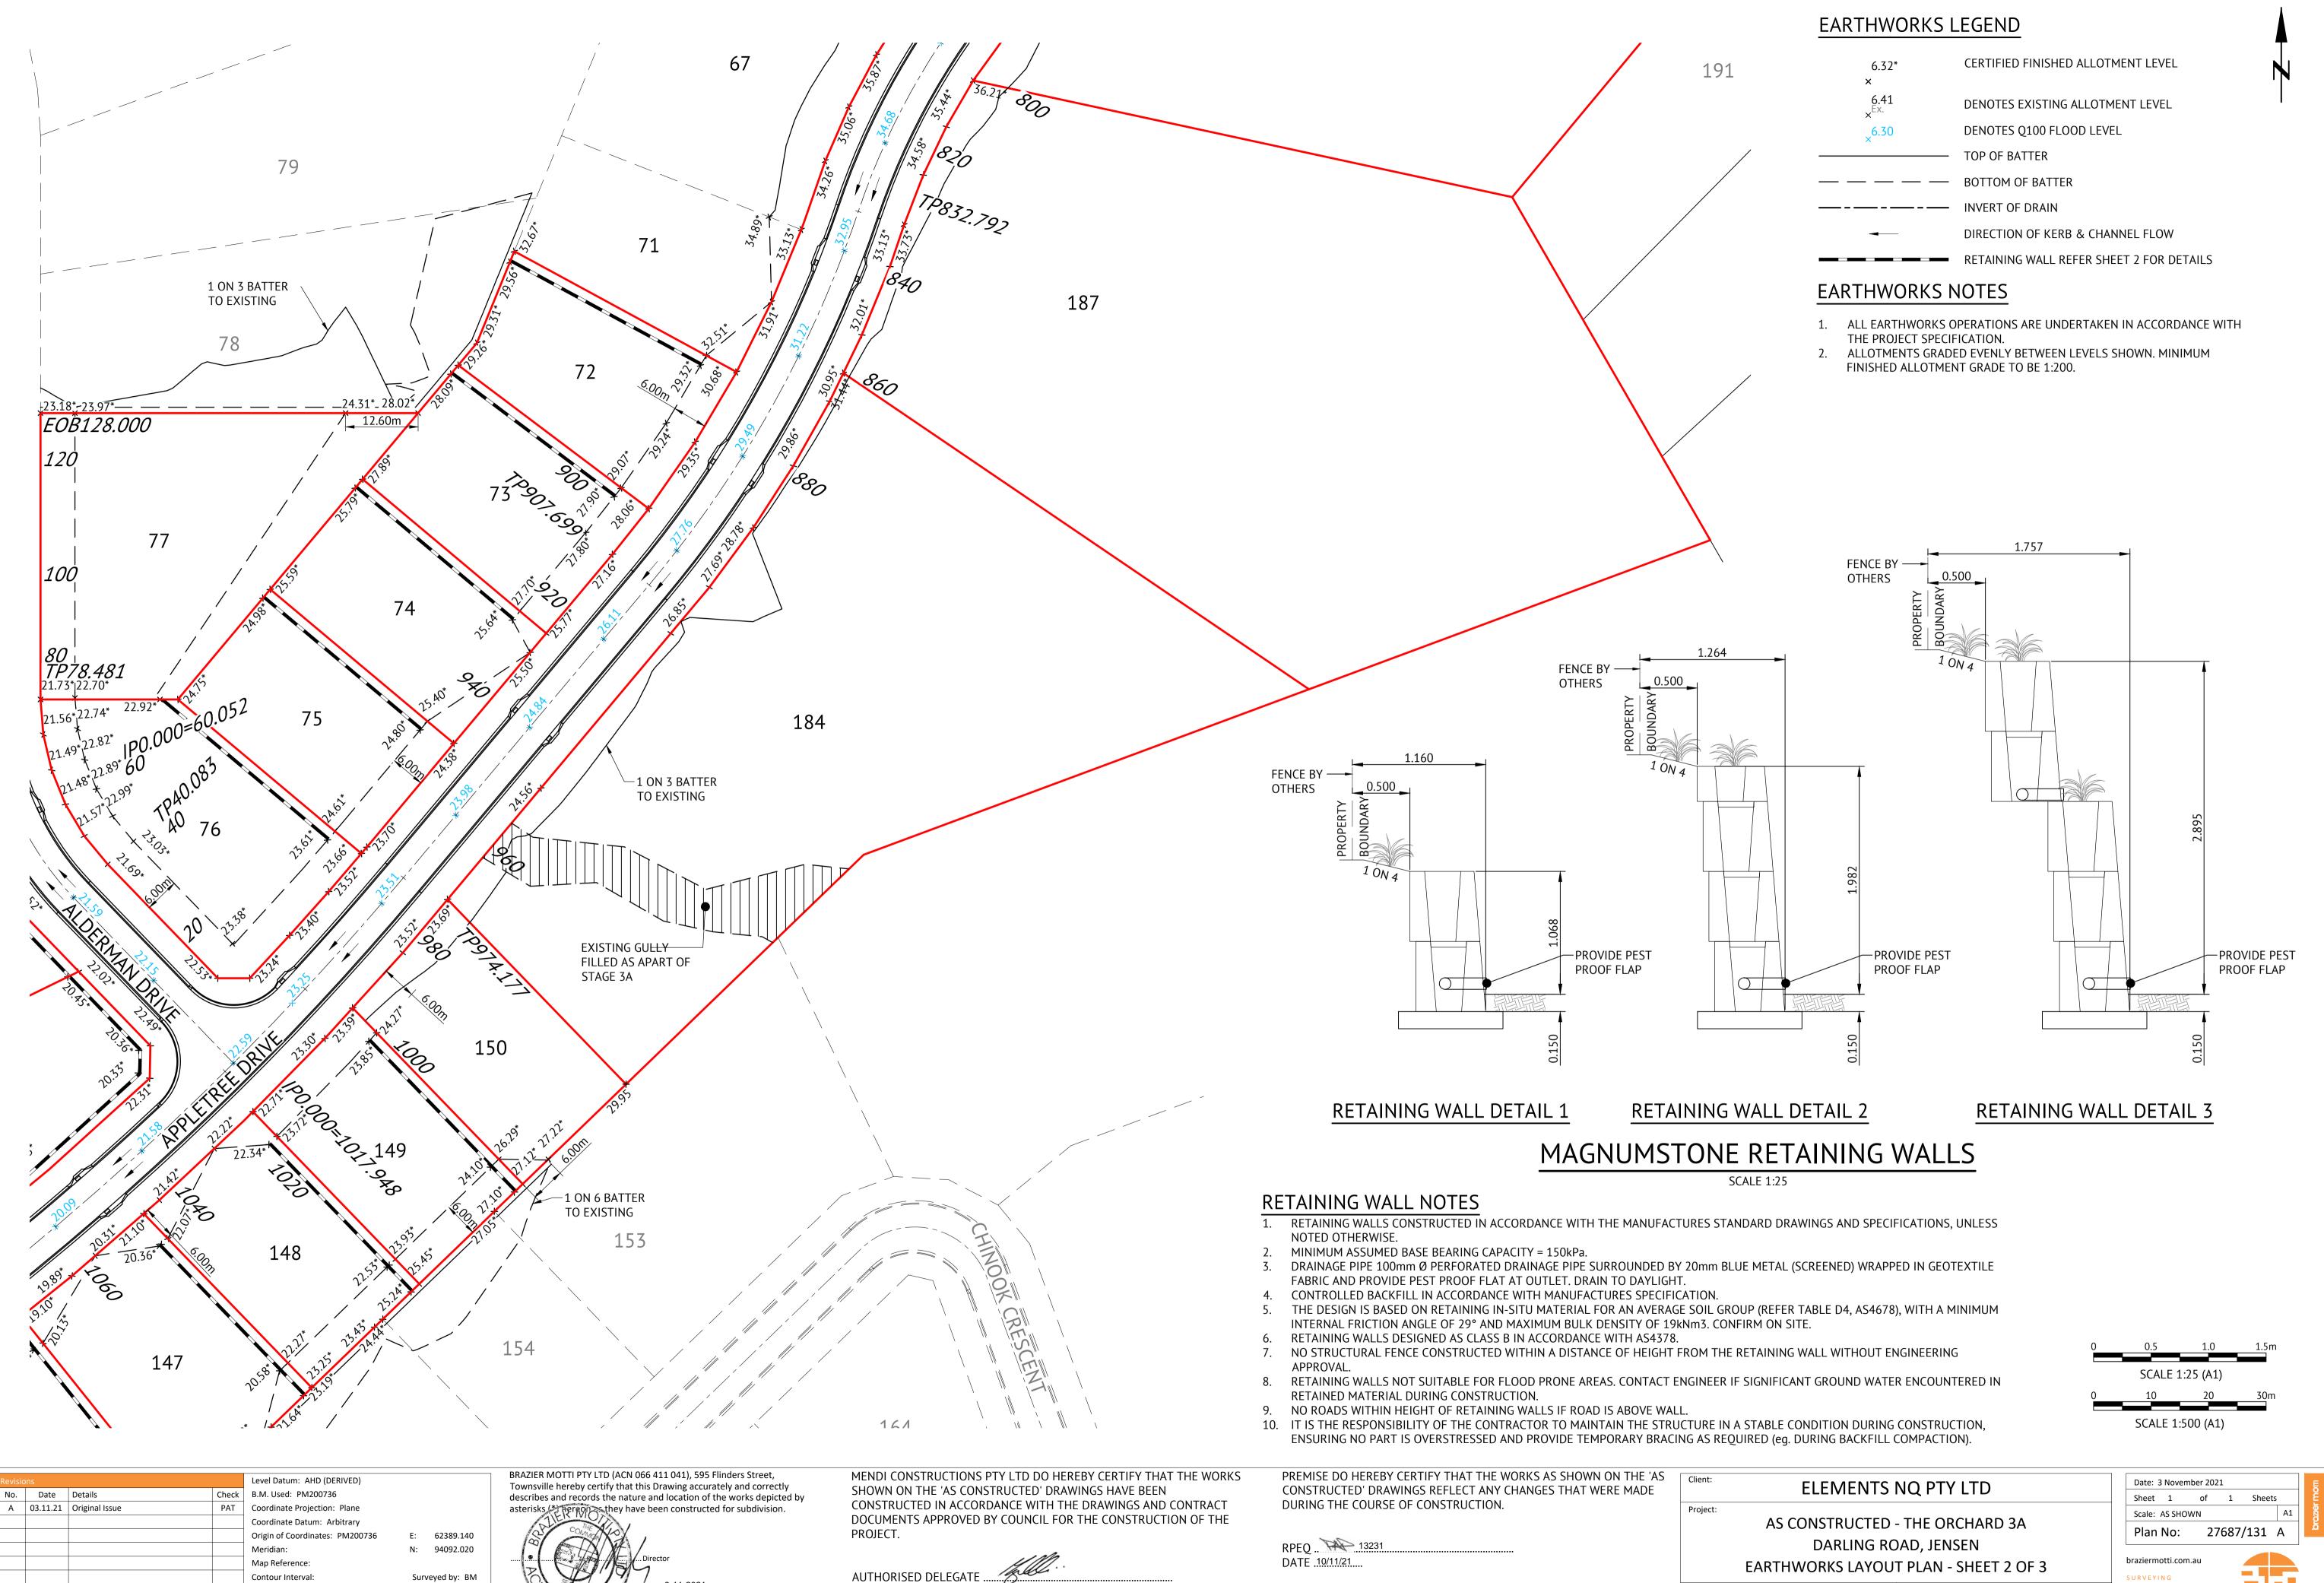

DATE09/11/2021.....

Job No: 27687-068-01

File No: 27687_131A.dwg

Drawn: MJM

TOWNPLANNING PROJECTMANAGEMENT MAPPING&GIS

Locality:

Local Authority: Townsville City Council



Job No: 27687-068-01

File No: 27687_132A.dwg

Drawn: MJM


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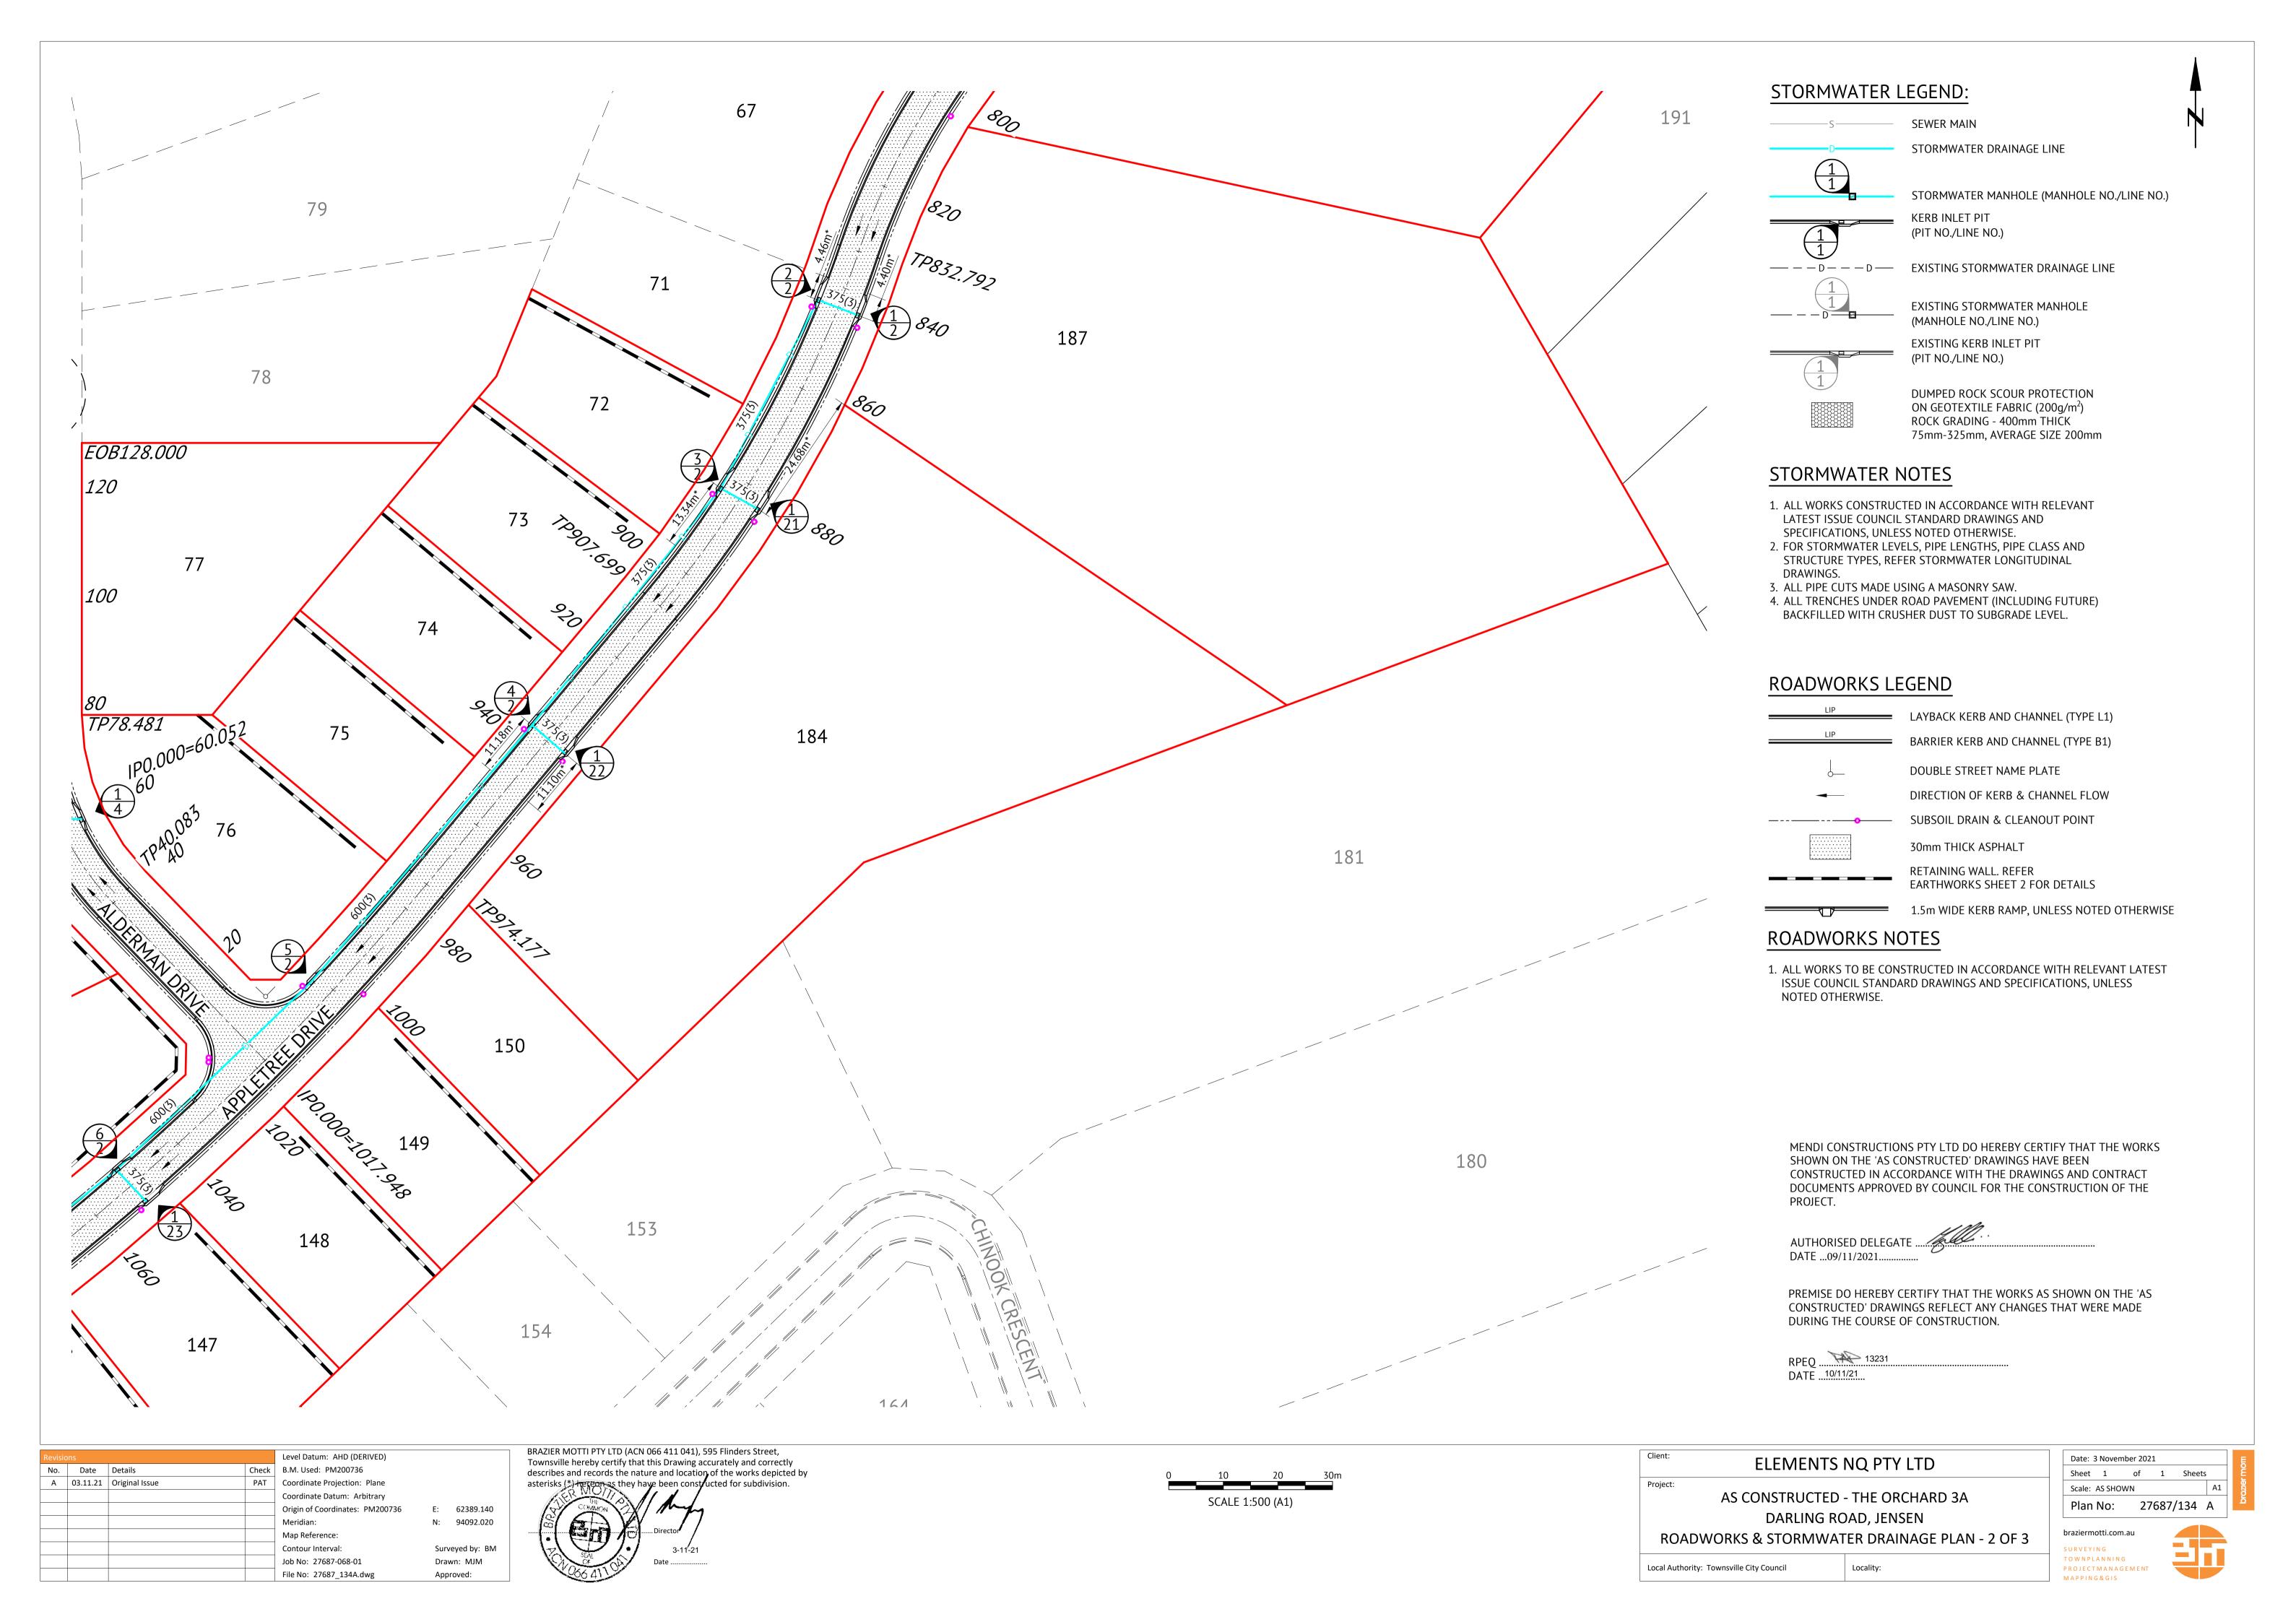
PROJECTMANAGEMENT MAPPING&GIS


Local Authority: Townsville City Council


Locality:

TOWNPLANNING



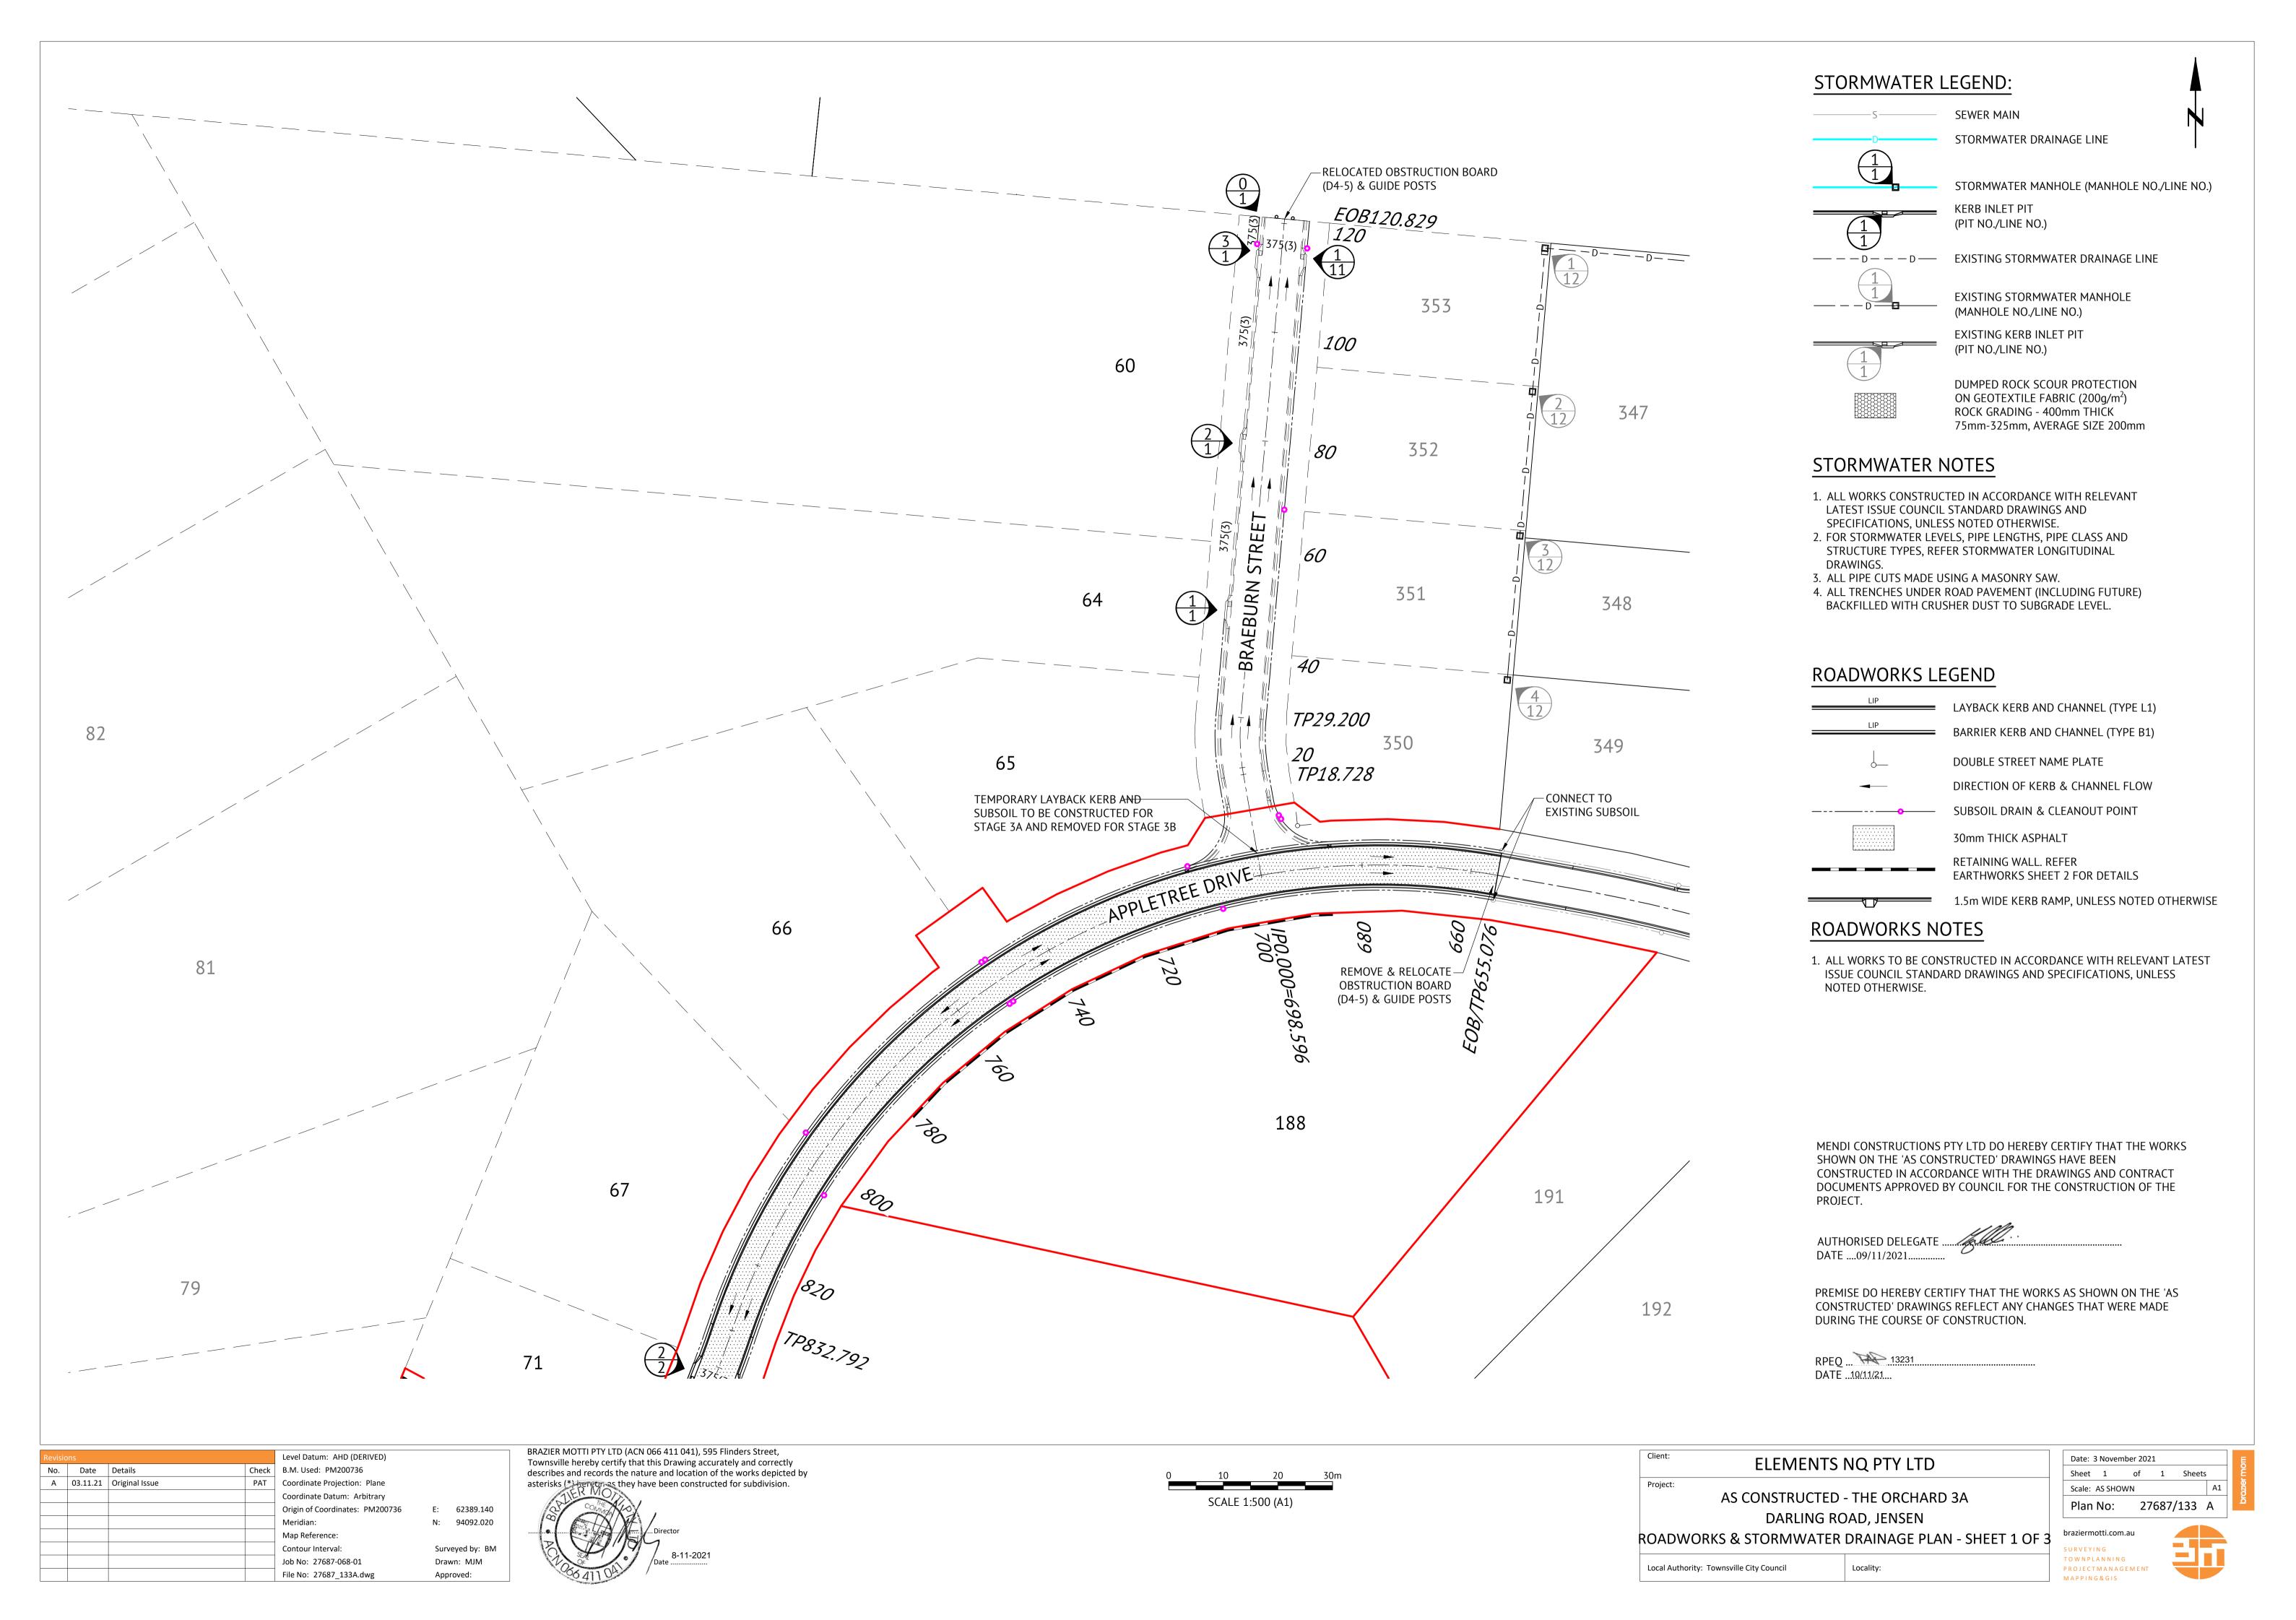

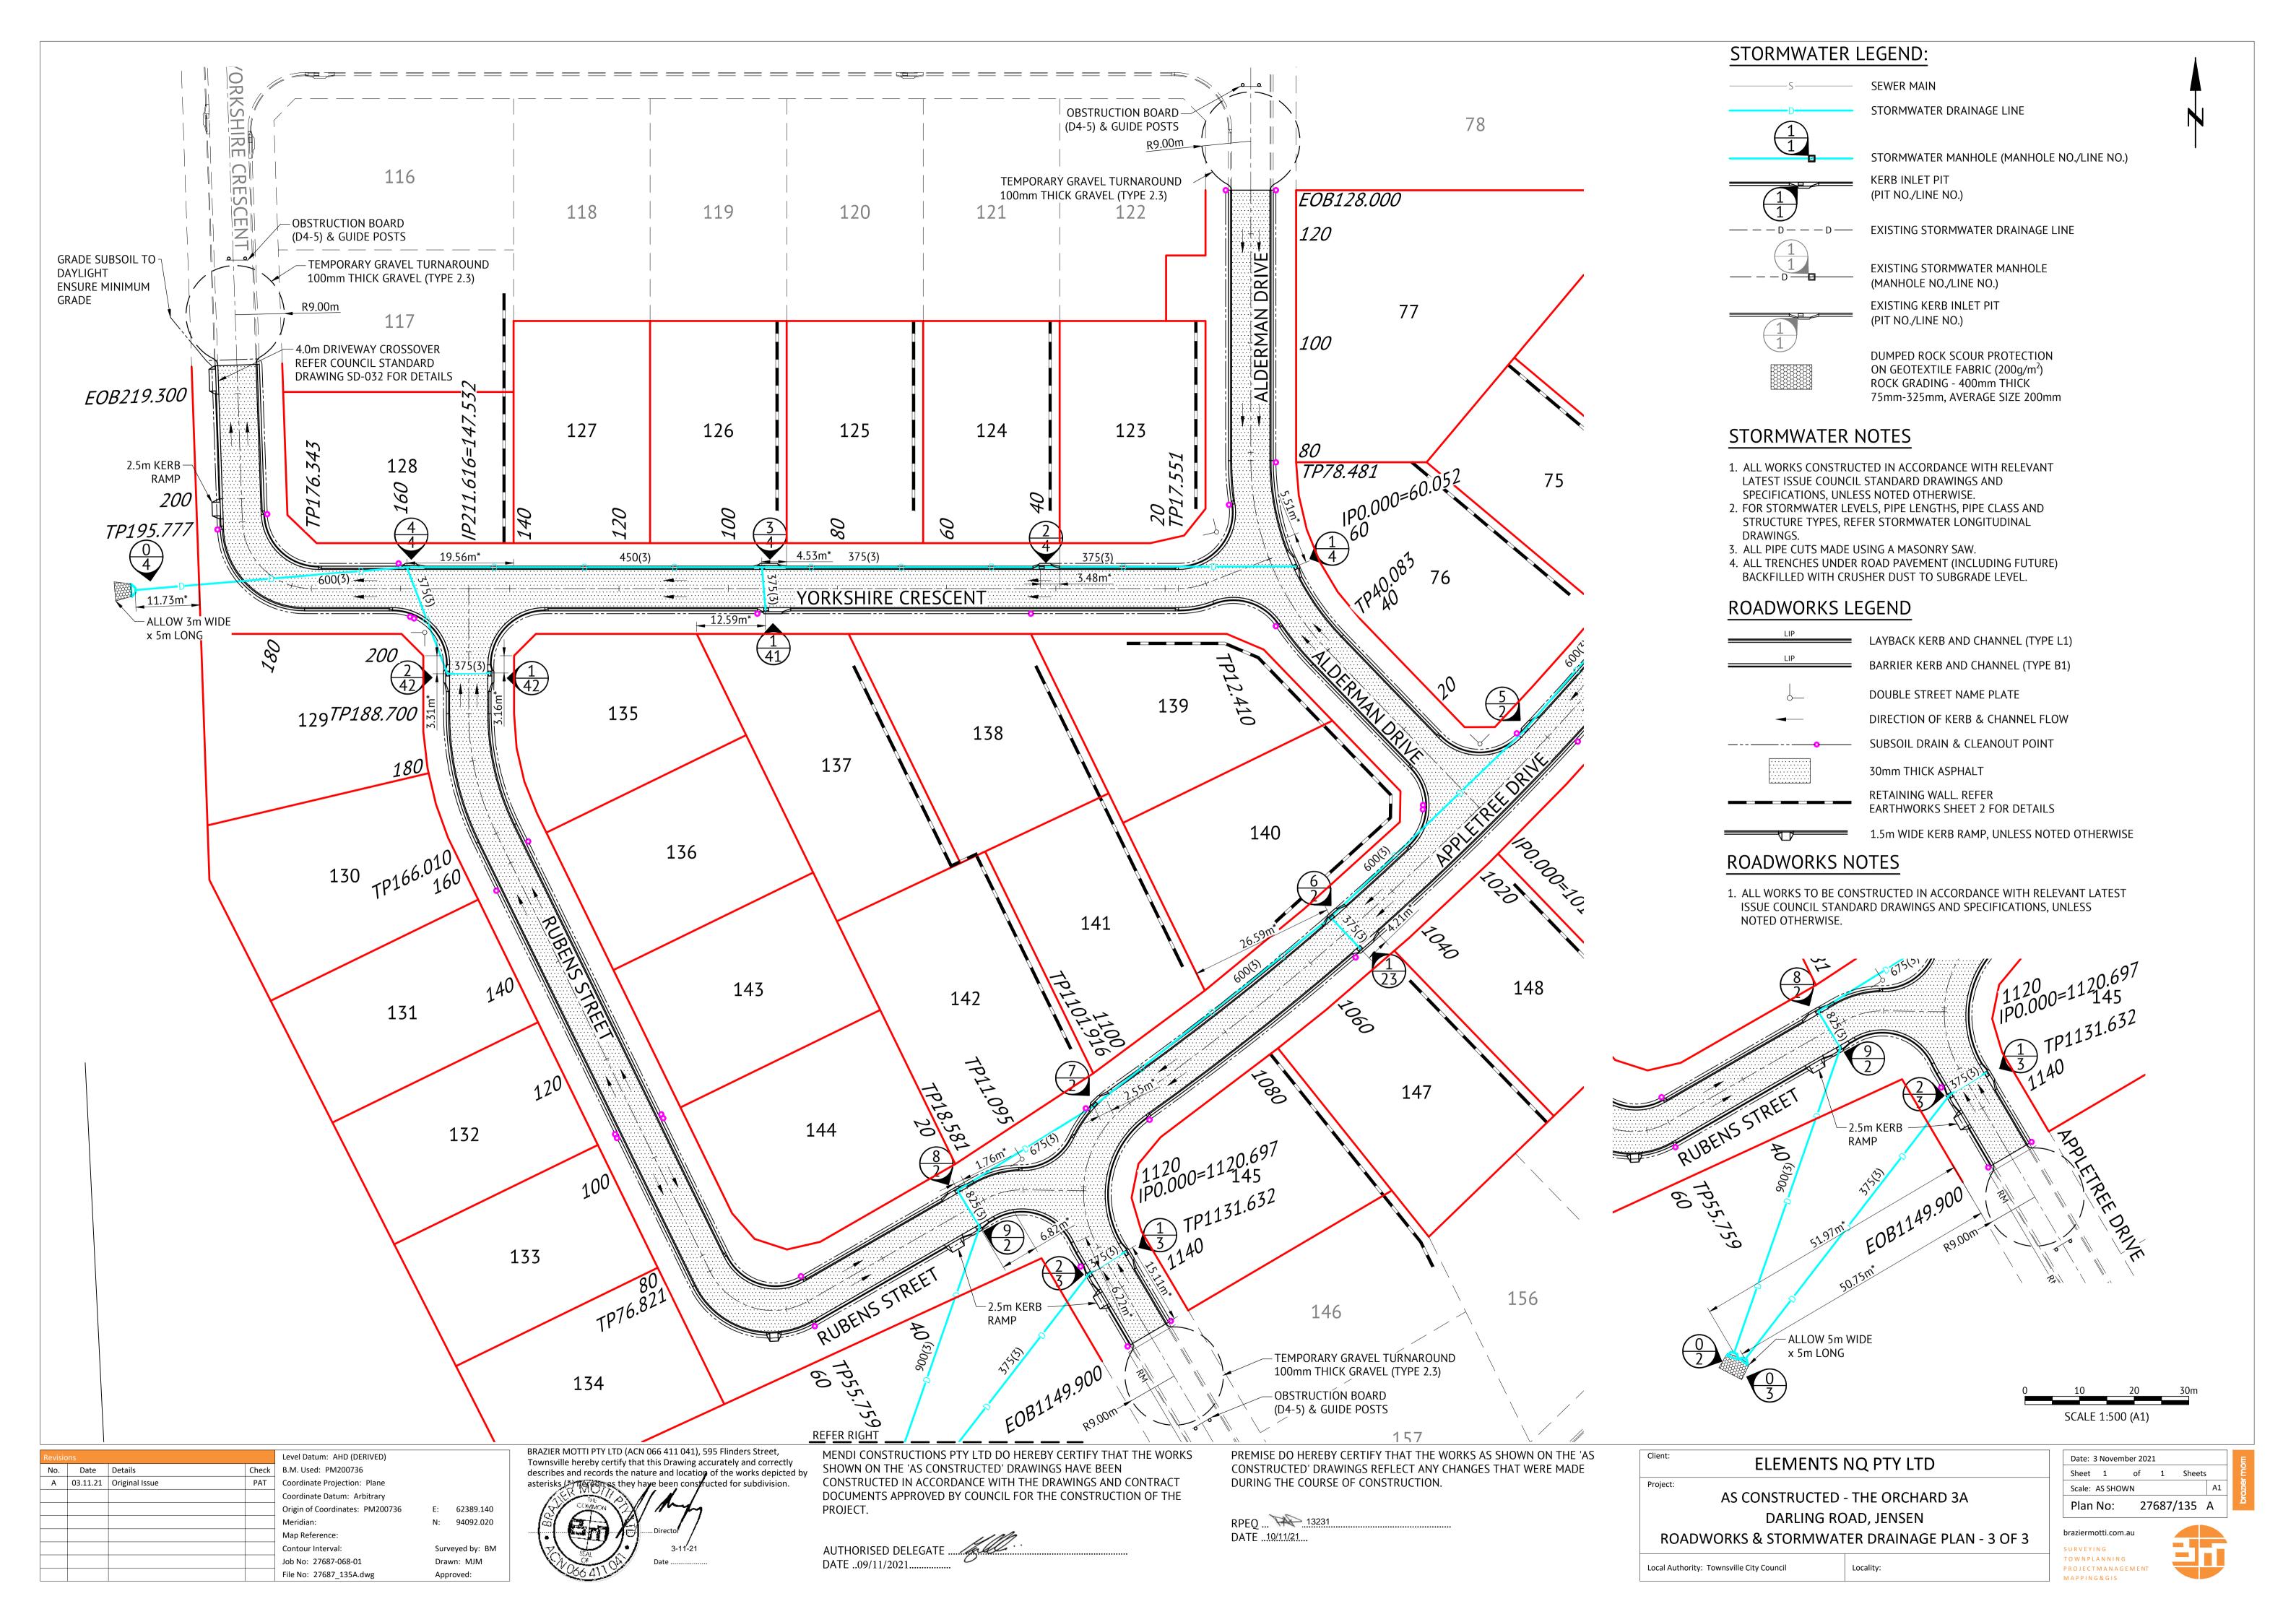

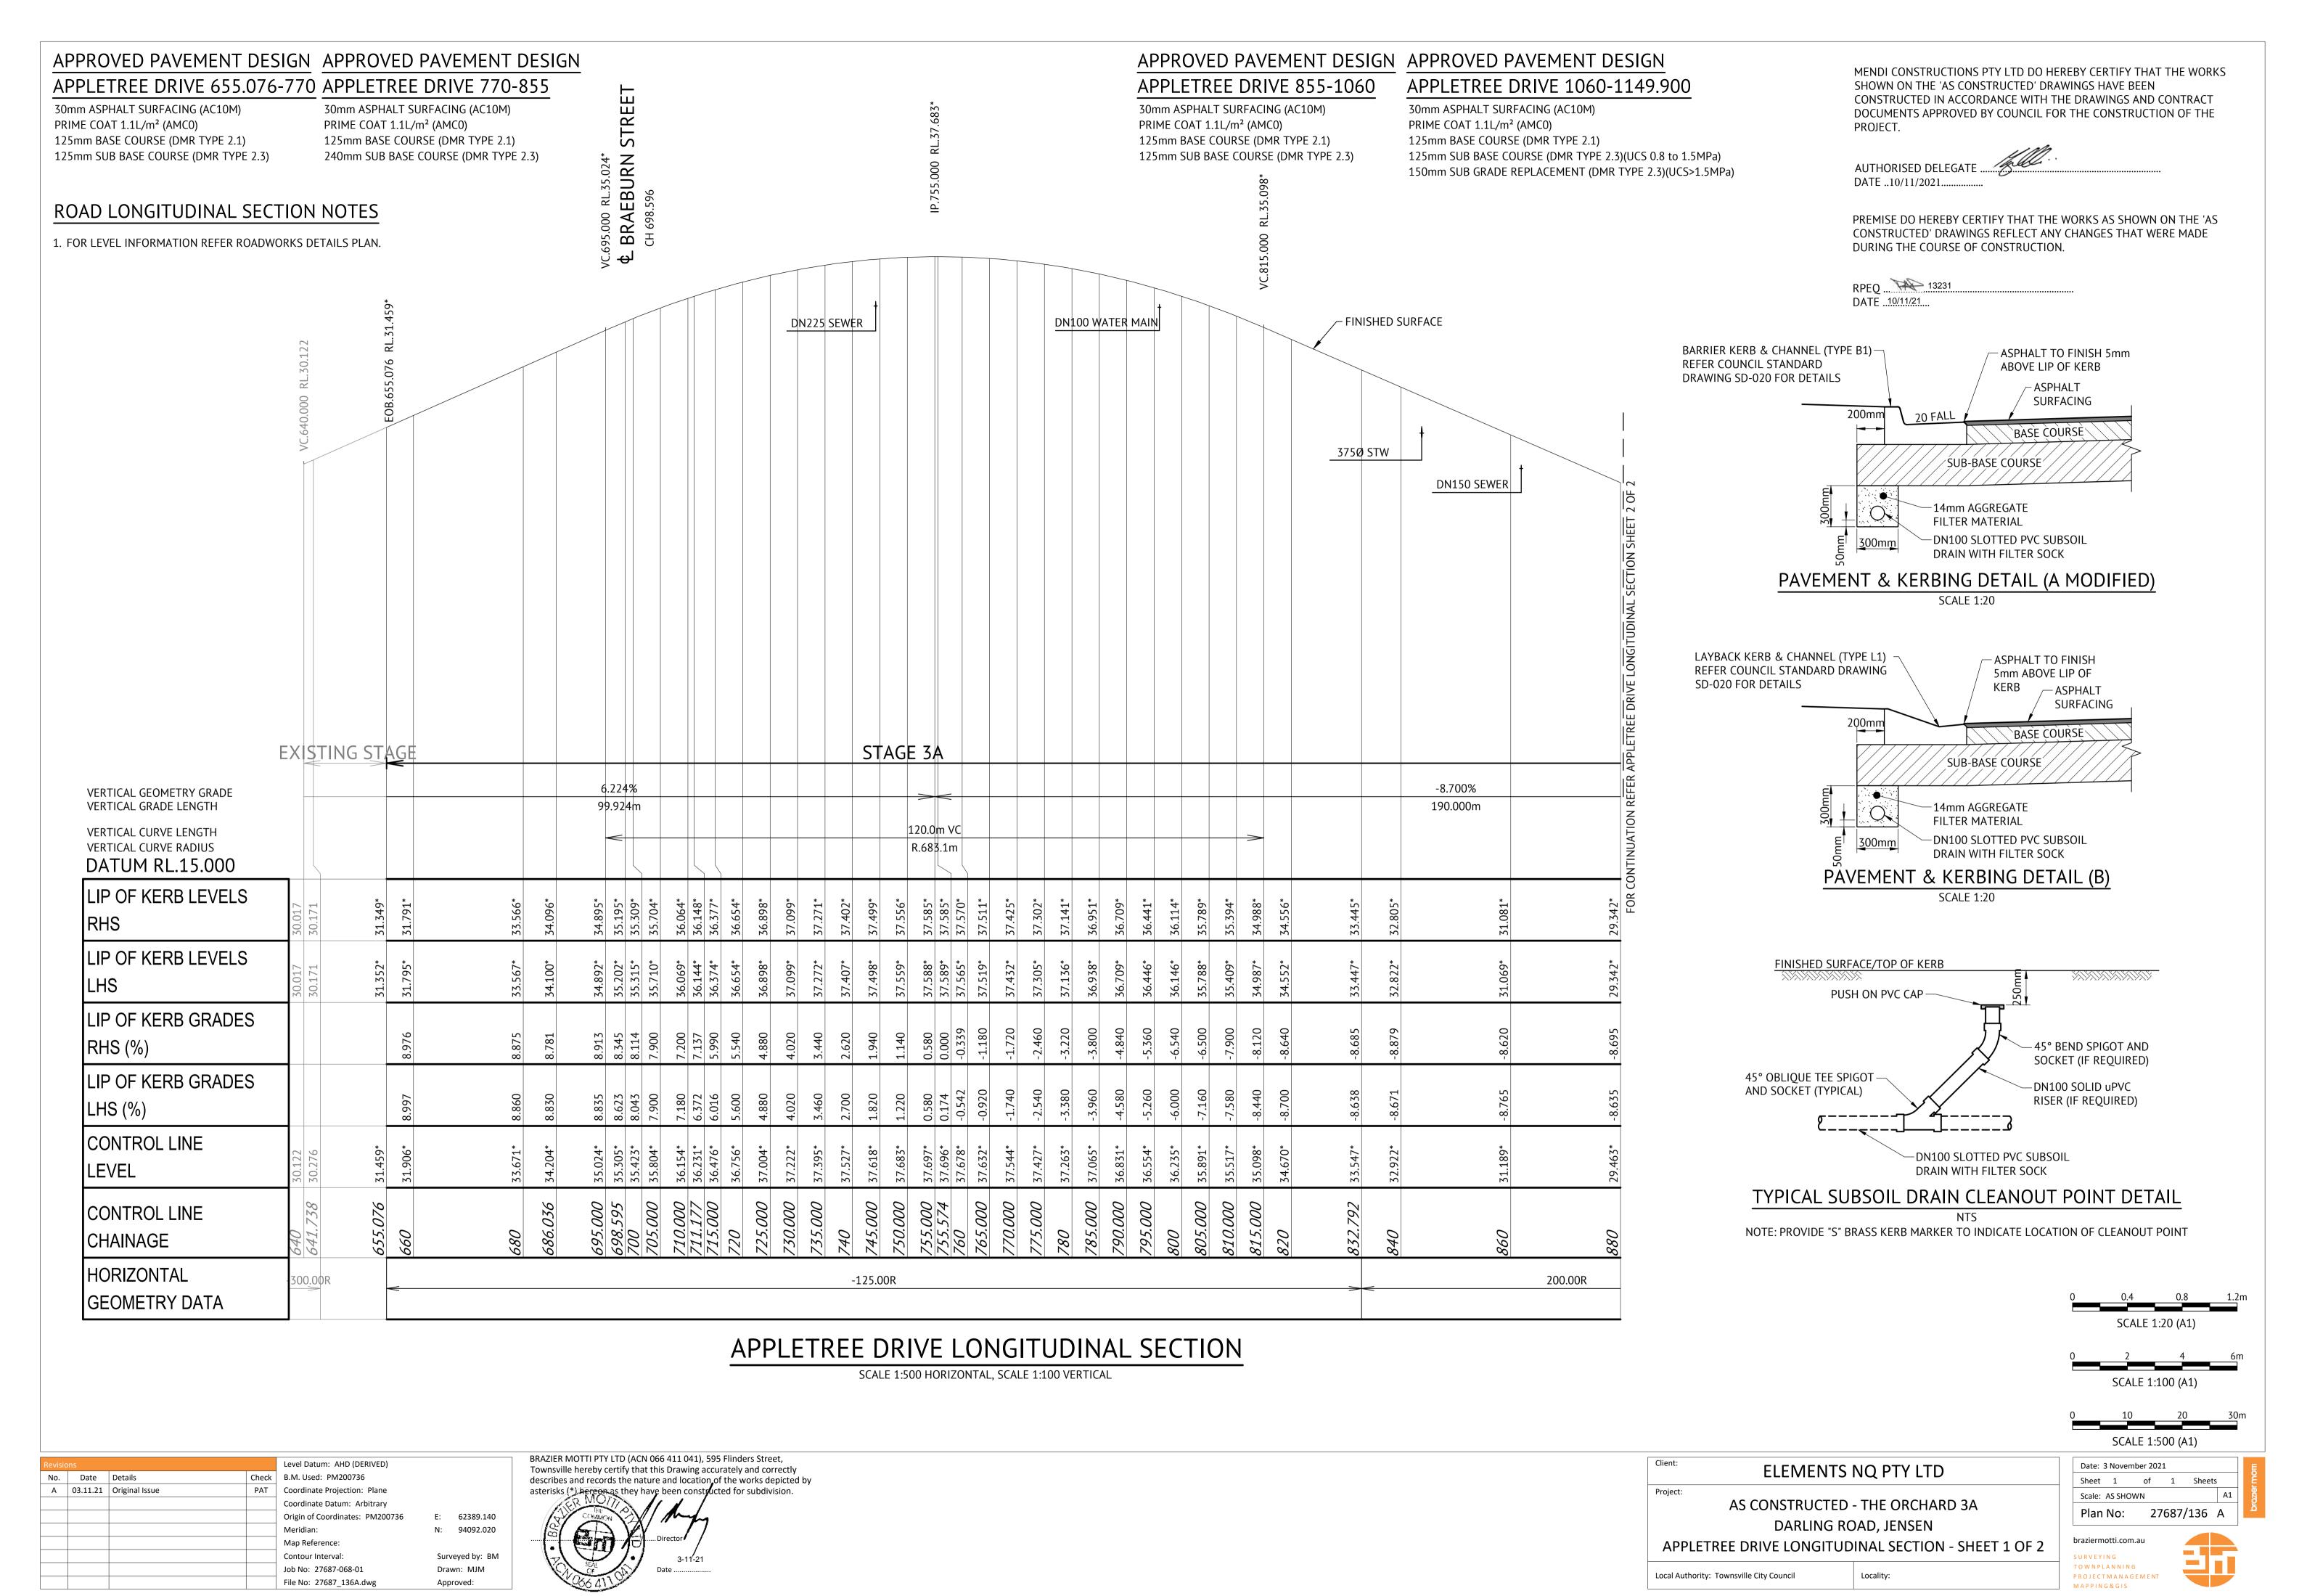



CONSTRUCTED IN ACCORDANCE WITH THE DRAWINGS AND CONTRACT DOCUMENTS APPROVED BY COUNCIL FOR THE CONSTRUCTION OF THE **AUTHORISED DELEGATE** DATE ..10/11/2021... ALDERMAN DRIVE PREMISE DO HEREBY CERTIFY THAT THE WORKS AS SHOWN ON THE 'AS CONSTRUCTED' DRAWINGS REFLECT ANY CHANGES THAT WERE MADE DURING THE COURSE OF CONSTRUCTION. RPEQ ... 13231 DATE ..10/11/21... 375Ø STW DN100 WATER MAIN 375Ø STW FINISHED SURFACE DN150 SEWER 375Ø STW EXISTING SURFACE DN150 WATER MAIN 630D WATER MAIN | 375Ø STW DN150 SEWER STAGE 3A -7.328% -8.700% -1.159% VERTICAL GEOMETRY GRADE VERTICAL GRADE LENGTH 190.000m 75.000m 85.000m 71.000m 45.0m VC |75.0m √C | 75.0m VC VERTICAL CURVE LENGTH VERTICAL CURVE RADIUS R.980.8m R.700.0m R.928.9m DATUM RL.9.000 LIP OF KERB LEVELS 26.952*
26.934*
26.525*
26.126*
25.936*
25.936*
25.934*
25.934*
24.799*
24.799*
24.293*
24.293*
24.293*
24.293*
24.293*
24.293*
22.3780*
22.3780*
23.780*
23.780*
23.782*
23.342*
23.342*
23.342* 17.577* 17.481* 17.452* 17.404* 21.913* 21.873* 21.547* 21.372* 21.191* REFER REFER NOTE 1 LIP OF KERB LEVELS LIP OF KERB GRADES -15.020 -24.540 -3.840 -4.252 REFER -2.419 0.481 -0.220 0.000 0.000 0.680 0.622 NOTE 1 RHS (%) LIP OF KERB GRADES LHS (%) CONTROL LINE CONTROL LINE 907. 907. 927. 927. 947. 947. 960. 987. 987. **CHAINAGE HORIZONTAL** 200.00R 500.00R -20.00R **GEOMETRY DATA**

APPLETREE DRIVE LONGITUDINAL SECTION

SCALE 1:500 HORIZONTAL, SCALE 1:100 VERTICAL

Revisio	ons			Level Datum: AHD (DERIVED)		
No.	Date	Details	Check	B.M. Used: PM200736		
Α	03.11.21	Original Issue	PAT	Coordinate Projection: Plane		
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				Meridian:	N:	94092.020
				Map Reference:		
				Contour Interval:	Sur	veyed by: BM
				Job No: 27687-068-01	Dra	wn: MJM
				File No: 27687_137A.dwg	App	proved:

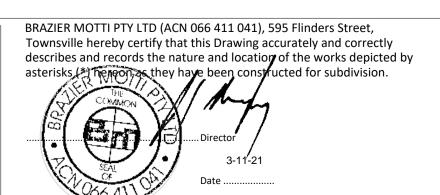

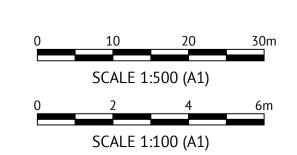

CI	ELEMENTS NQ PTY LTD
Pr	AS CONSTRUCTED - THE ORCHARD 3A
	DARLING ROAD, JENSEN
	APPLETREE DRIVE LONGITUDINAL SECTION - SHEET 2 OF 2

Locality:

Local Authority: Townsville City Council

Sheet 1 of 1 Sheets
Scale: AS SHOWN A1
Plan No: 27687/137 A


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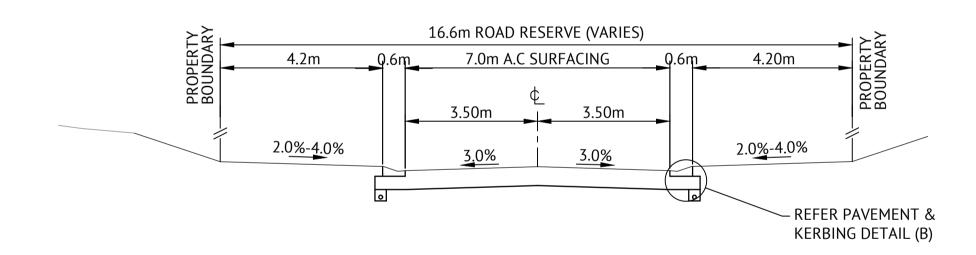
MENDI CONSTRUCTIONS PTY LTD DO HEREBY CERTIFY THAT THE WORKS

SHOWN ON THE 'AS CONSTRUCTED' DRAWINGS HAVE BEEN






TYPICAL SECTION CH.1132.916 - CH.1149.900

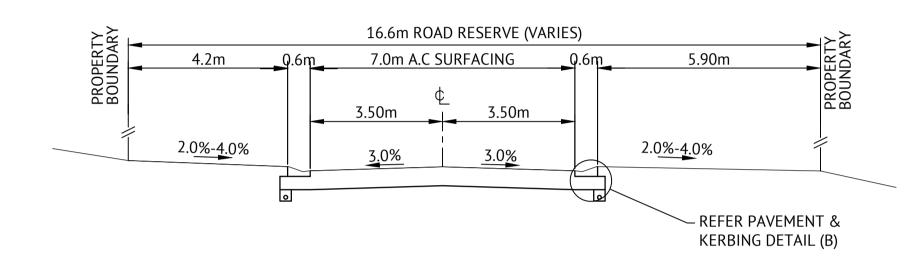

TYPICAL SECTION CH. 655.076 - CH.1132.916

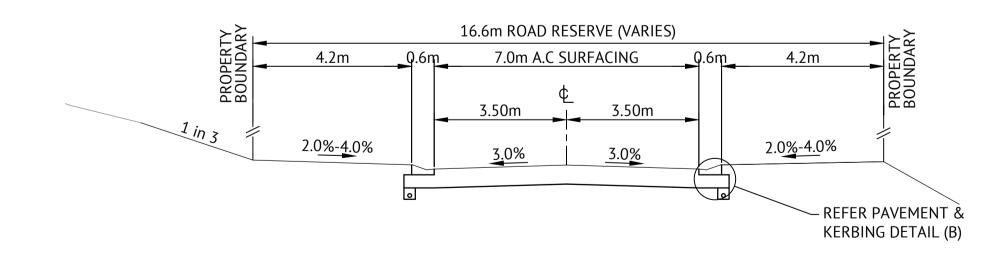

TYPICAL SECTION CH. 655.076 - CH.1132.916 APPLETREE DRIVE CROSS SECTIONS SCALE 1:100

Revisi	Revisions			Level Datum: AHD (DERIVED)		
No.	Date	Details	Check	B.M. Used: PM200736		
Α	03.11.21	Original Issue	PAT	Coordinate Projection: Plane		
				Coordinate Datum: Arbitrary		
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				Meridian:	N:	94092.020
				Map Reference:		
				Contour Interval:	Surv	veyed by: BN
				Job No: 27687-068-01	Dra	wn: MJM
				File No: 27687 138A.dwg	aqA	roved:

DURING THE COURSE OF CONSTRUCTION.

MENDI CONSTRUCTIONS PTY LTD DO HEREBY CERTIFY THAT THE WORKS

CONSTRUCTED IN ACCORDANCE WITH THE DRAWINGS AND CONTRACT

DOCUMENTS APPROVED BY COUNCIL FOR THE CONSTRUCTION OF THE


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SHOWN ON THE 'AS CONSTRUCTED' DRAWINGS HAVE BEEN

PROJECT.

DATE ...10/11/21



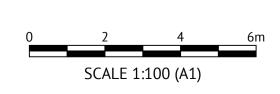

Client:	ELEMENTS	NQ PTY LTD
Project:		
	AS CONSTRUCTED	- THE ORCHARD 3A
	DARLING RO	OAD, JENSEN
	APPLETREE DRIV	E CROSS SECTIONS



SURVEYING TOWNPLANNING MAPPING&GIS

PROJECTMANAGEMENT



APPROVED PAVEMENT DESIGN APPROVED PAVEMENT DESIGN

ALDERMAN DRIVE 00-80.000
30mm ASPHALT SURFACING (AC10M)


ALDERMAN DRIVE 80.000-128.000

30mm ASPHALT SURFACING (AC10M)
PRIME COAT 1.1L/m² (AMC0)
125mm BASE COURSE (DMR TYPE 2.1)

PRIME COAT 1.1L/m² (AMCO)
125mm BASE COURSE (DMR TYPE 2.1)
125mm SUB BASE COURSE (DMR TYPE 2.3)

125mm BASE COURSE (DMR TYPE 2.1)
125mm SUB BASE COURSE (DMR TYPE 2.3)(UCS 0.8 to 1.5MPa)
150mm SUB GRADE REPLACEMENT (DMR TYPE 2.3)(UCS > 1.5MPa)


ROAD LONGITUDINAL SECTION NOTES

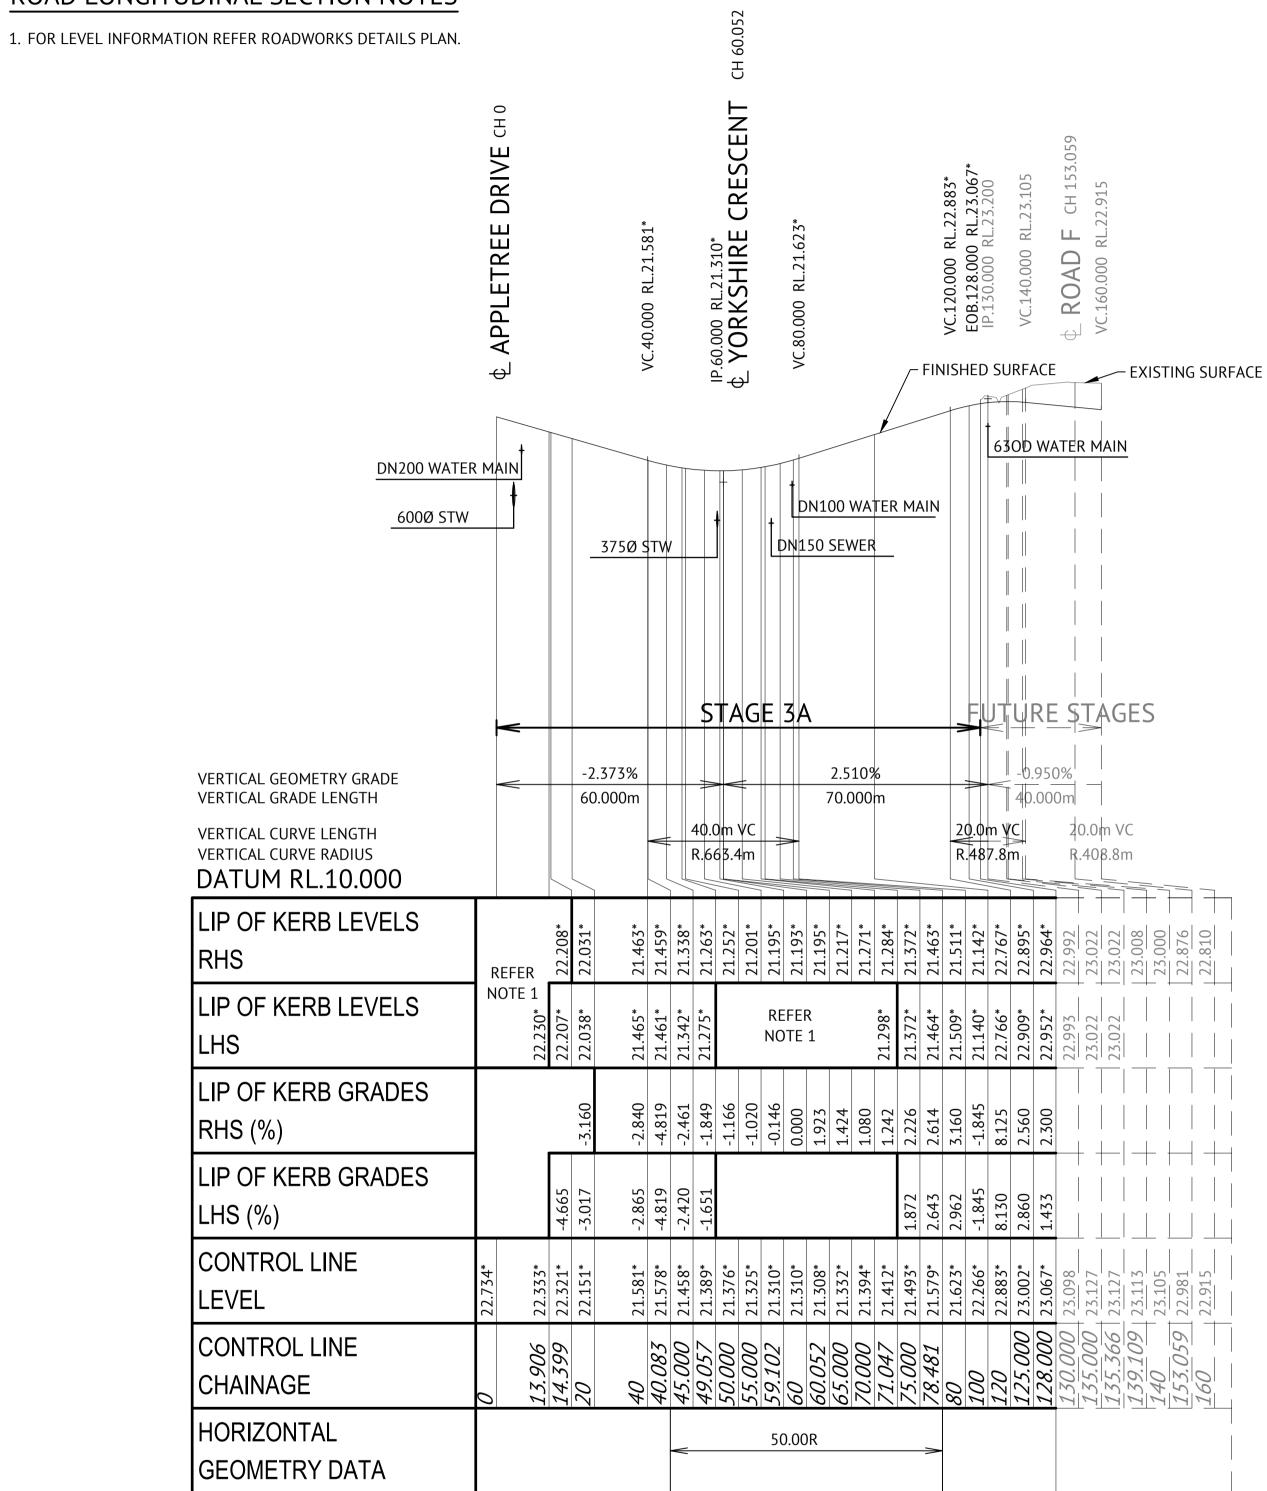

ALDERMAN DRIVE LONGITUDINAL SECTION

SCALE 1:1000 HORIZONTAL, SCALE 1:100 VERTICAL

Level Datum: AHD (DERIVED) B.M. Used: PM200736 A 03.11.21 Original Issue Coordinate Projection: Plane Coordinate Datum: Arbitrary Origin of Coordinates: PM200736 62389.140 N: 94092.020 Meridian: Map Reference: Contour Interval: Surveyed by: BM Job No: 27687-068-01 Drawn: MJM File No: 27687 140A.dwg Approved:

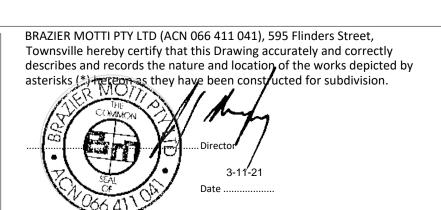


CONSTRUCTED IN ACCORDANCE WITH THE DRAWINGS AND CONTRACT DOCUMENTS APPROVED BY COUNCIL FOR THE CONSTRUCTION OF THE PROJECT.

MENDI CONSTRUCTIONS PTY LTD DO HEREBY CERTIFY THAT THE WORKS

AUTHORISED DELEGATEDATE10/11/2021.....

SHOWN ON THE 'AS CONSTRUCTED' DRAWINGS HAVE BEEN


PREMISE DO HEREBY CERTIFY THAT THE WORKS AS SHOWN ON THE 'AS CONSTRUCTED' DRAWINGS REFLECT ANY CHANGES THAT WERE MADE DURING THE COURSE OF CONSTRUCTION.

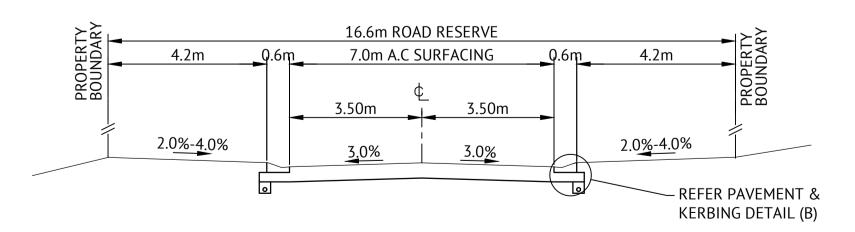

ALDERMAN DRIVE CROSS SECTIONS

Local Authority: Townsville City Council

SCALE 1:100

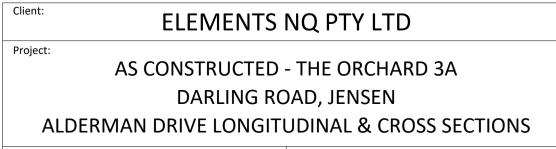

Locality:

Date: 3 November 2021

Sheet 1 of 1 Sheets


Scale: AS SHOWN A1

Plan No: 27687/140 A

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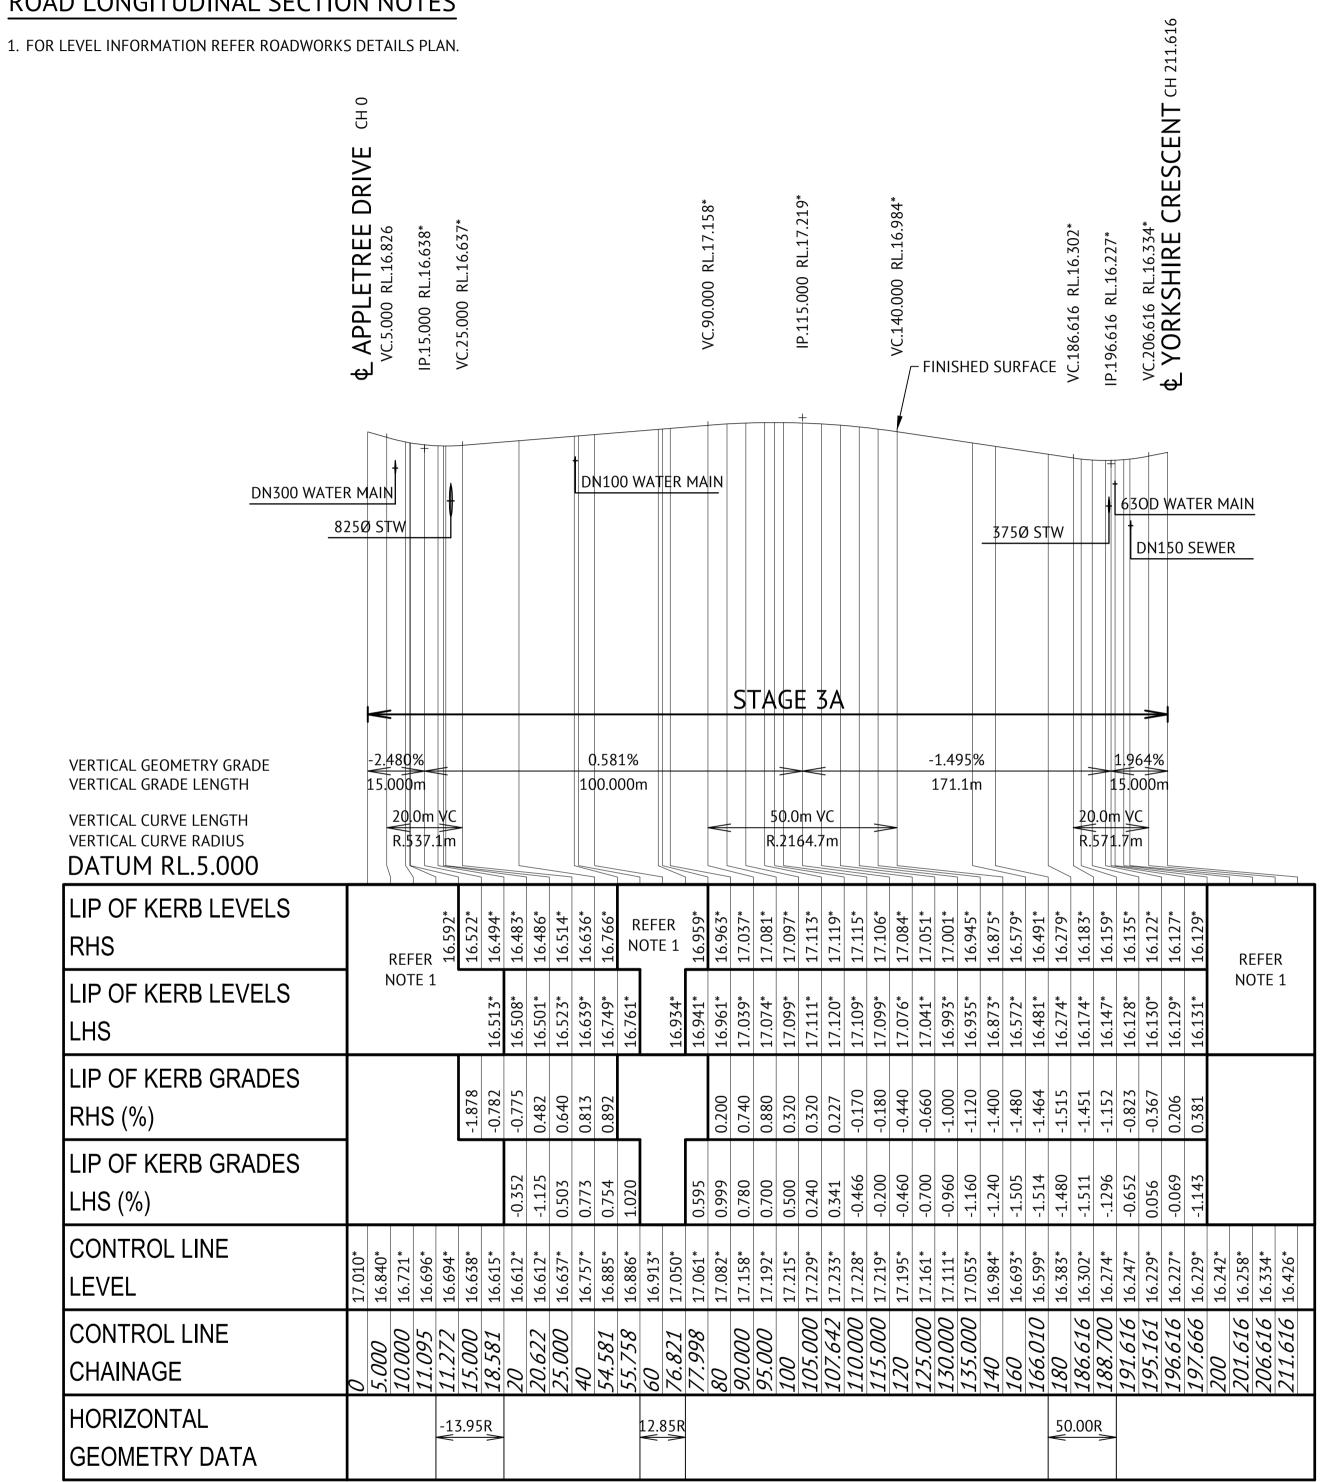


APPROVED PAVEMENT DESIGN

RUBENS STREET

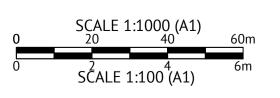30mm ASPHALT SURFACING (AC10M) PRIME COAT 1.1L/m² (AMCO) 125mm BASE COURSE (DMR TYPE 2.1) 125mm SUB BASE COURSE (DMR TYPE 2.3)(UCS 0.8 to 1.5MPa) 150mm SUB GRADE REPLACEMENT (DMR TYPE 2.3)(UCS > 1.5MPa)

ROAD LONGITUDINAL SECTION NOTES



RUBENS STREET LONGITUDINAL SECTION


SCALE 1:1000 HORIZONTAL, SCALE 1:100 VERTICAL

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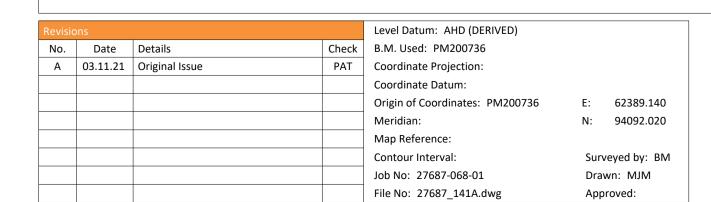
RPEQ 13231 DATE ...10/11/21...





RUBENS STREET CROSS SECTIONS

TYPICAL SECTION CH. 0.000 - CH.77.998

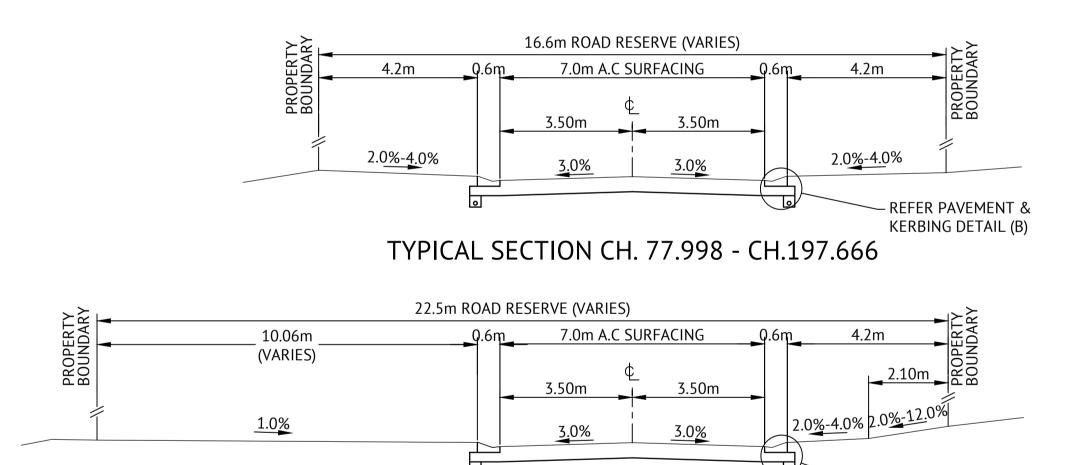SCALE 1:100



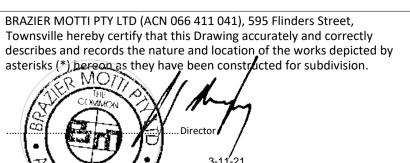

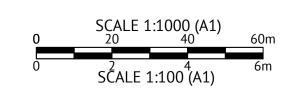

ELEMENTS NQ PTY LTD	
Project:	
AS CONSTRUCTED - THE ORCHARD 3A	
DARLING ROAD, JENSEN	
RUBENS STREET LONGITUDINAL & CROSS SECTION	۱S

- REFER PAVEMENT &

KERBING DETAIL (B)

Plan No: 27687/141 A braziermotti.com.au

Date: 3 November 2021

Scale: AS SHOWN

Local Authority: Townsville City Council

Locality:

TOWNPLANNING PROJECTMANAGEMENT MAPPING&GIS




APPROVED PAVEMENT DESIGN APPROVED PAVEMENT DESIGN YORKSHIRE CRESCENT (CH20.000-219.3) YORKSHIRE CRESCENT (CH0-20.000) 30mm ASPHALT SURFACING (AC10M) 30mm ASPHALT SURFACING (AC10M) PRIME COAT 1.1L/m² (AMC0) PRIME COAT 1.1L/m² (AMCO) 125mm BASE COURSE (DMR TYPE 2.1) 125mm BASE COURSE (DMR TYPE 2.1) 125mm SUB BASE COURSE (DMR TYPE 2.3) 125mm SUB BASE COURSE (DMR TYPE 2.3)(UCS 0.8 to 1.5MPa) 150mm SUBGRADE REPLACEMENT (DMR TYPE 2.3)(UCS>1.5MPa) ROAD LONGITUDINAL SECTION NOTES 1. FOR LEVEL INFORMATION REFER ROADWORKS DETAILS PLAN. STREET 275.000 RL.15.150 ROAD F CH 281 RUBENS 375Ø STW FINISHED SURFACE 375Ø STW DN150 WATER MAIN 375Ø STW 600Ø \$TW DN100 WATER MAIN DN150 SEWER STAGE 3A -1.134% -3.275% -4.772% VERTICAL GEOMETRY GRADE 40.000m 175.000m VERTICAL GRADE LENGTH 60.000m | 40.0m VC | 40.0m VC VERTICAL CURVE LENGTH REFER **VERTICAL CURVE RADIUS** R.1715.3m R.923.1m NOTE 1 **DATUM RL.3.000** LIP OF KERB LEVELS 16.181* NOTE 1 LIP OF KERB LEVELS 15.841* 15.834* 15.786* NOTE 1 LIP OF KERB GRADES -0.948 RHS (%) LIP OF KERB GRADES LHS (%) NOTE 1 CONTROL LINE LEVEL CONTROL LINE CHAINAGE HORIZONTAL 12.65R GEOMETRY DATA

YORKSHIRE CRESCENT LONGITUDINAL SECTION

SCALE 1:1000 HORIZONTAL, SCALE 1:100 VERTICAL

Level Datum: AHD (DERIVED) B.M. Used: PM200736 A 03.11.21 Original Issue Coordinate Projection: Coordinate Datum: Origin of Coordinates: PM200736 62389.140 94092.020 Meridian: Map Reference: Contour Interval: Surveyed by: BM Job No: 27687-068-01 Drawn: MJM



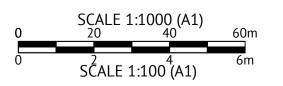


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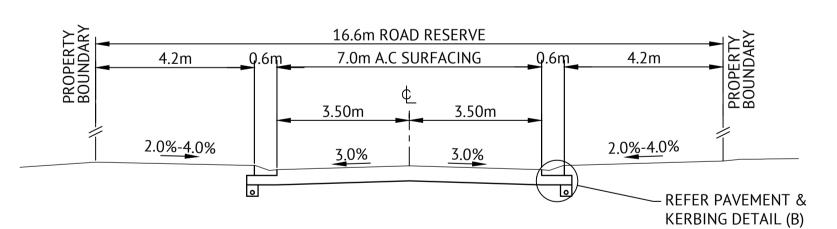


PREMISE DO HEREBY CERTIFY THAT THE WORKS AS SHOWN ON THE 'AS CONSTRUCTED' DRAWINGS REFLECT ANY CHANGES THAT WERE MADE DURING THE COURSE OF CONSTRUCTION.

RPEQ ... 13231 DATE ...10/11/21

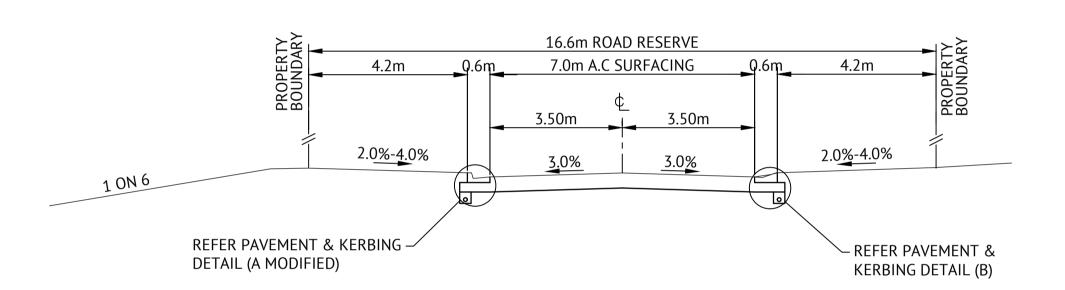

TYPICAL SECTION CH.197.032 - CH.219.300



TYPICAL SECTION CH.0.000 - CH.197.032

YORKSHIRE CRESCENT CROSS SECTIONS

ELEMENTS NQ PTY LTD AS CONSTRUCTED - THE ORCHARD 3A DARLING ROAD, JENSEN YORKSHIRE CRESCENT LONGITUDINAL & CROSS SECTIONS


Locality:


Local Authority: Townsville City Council

Plan No: braziermotti.com.au TOWNPLANNING

Scale: AS SHOWN



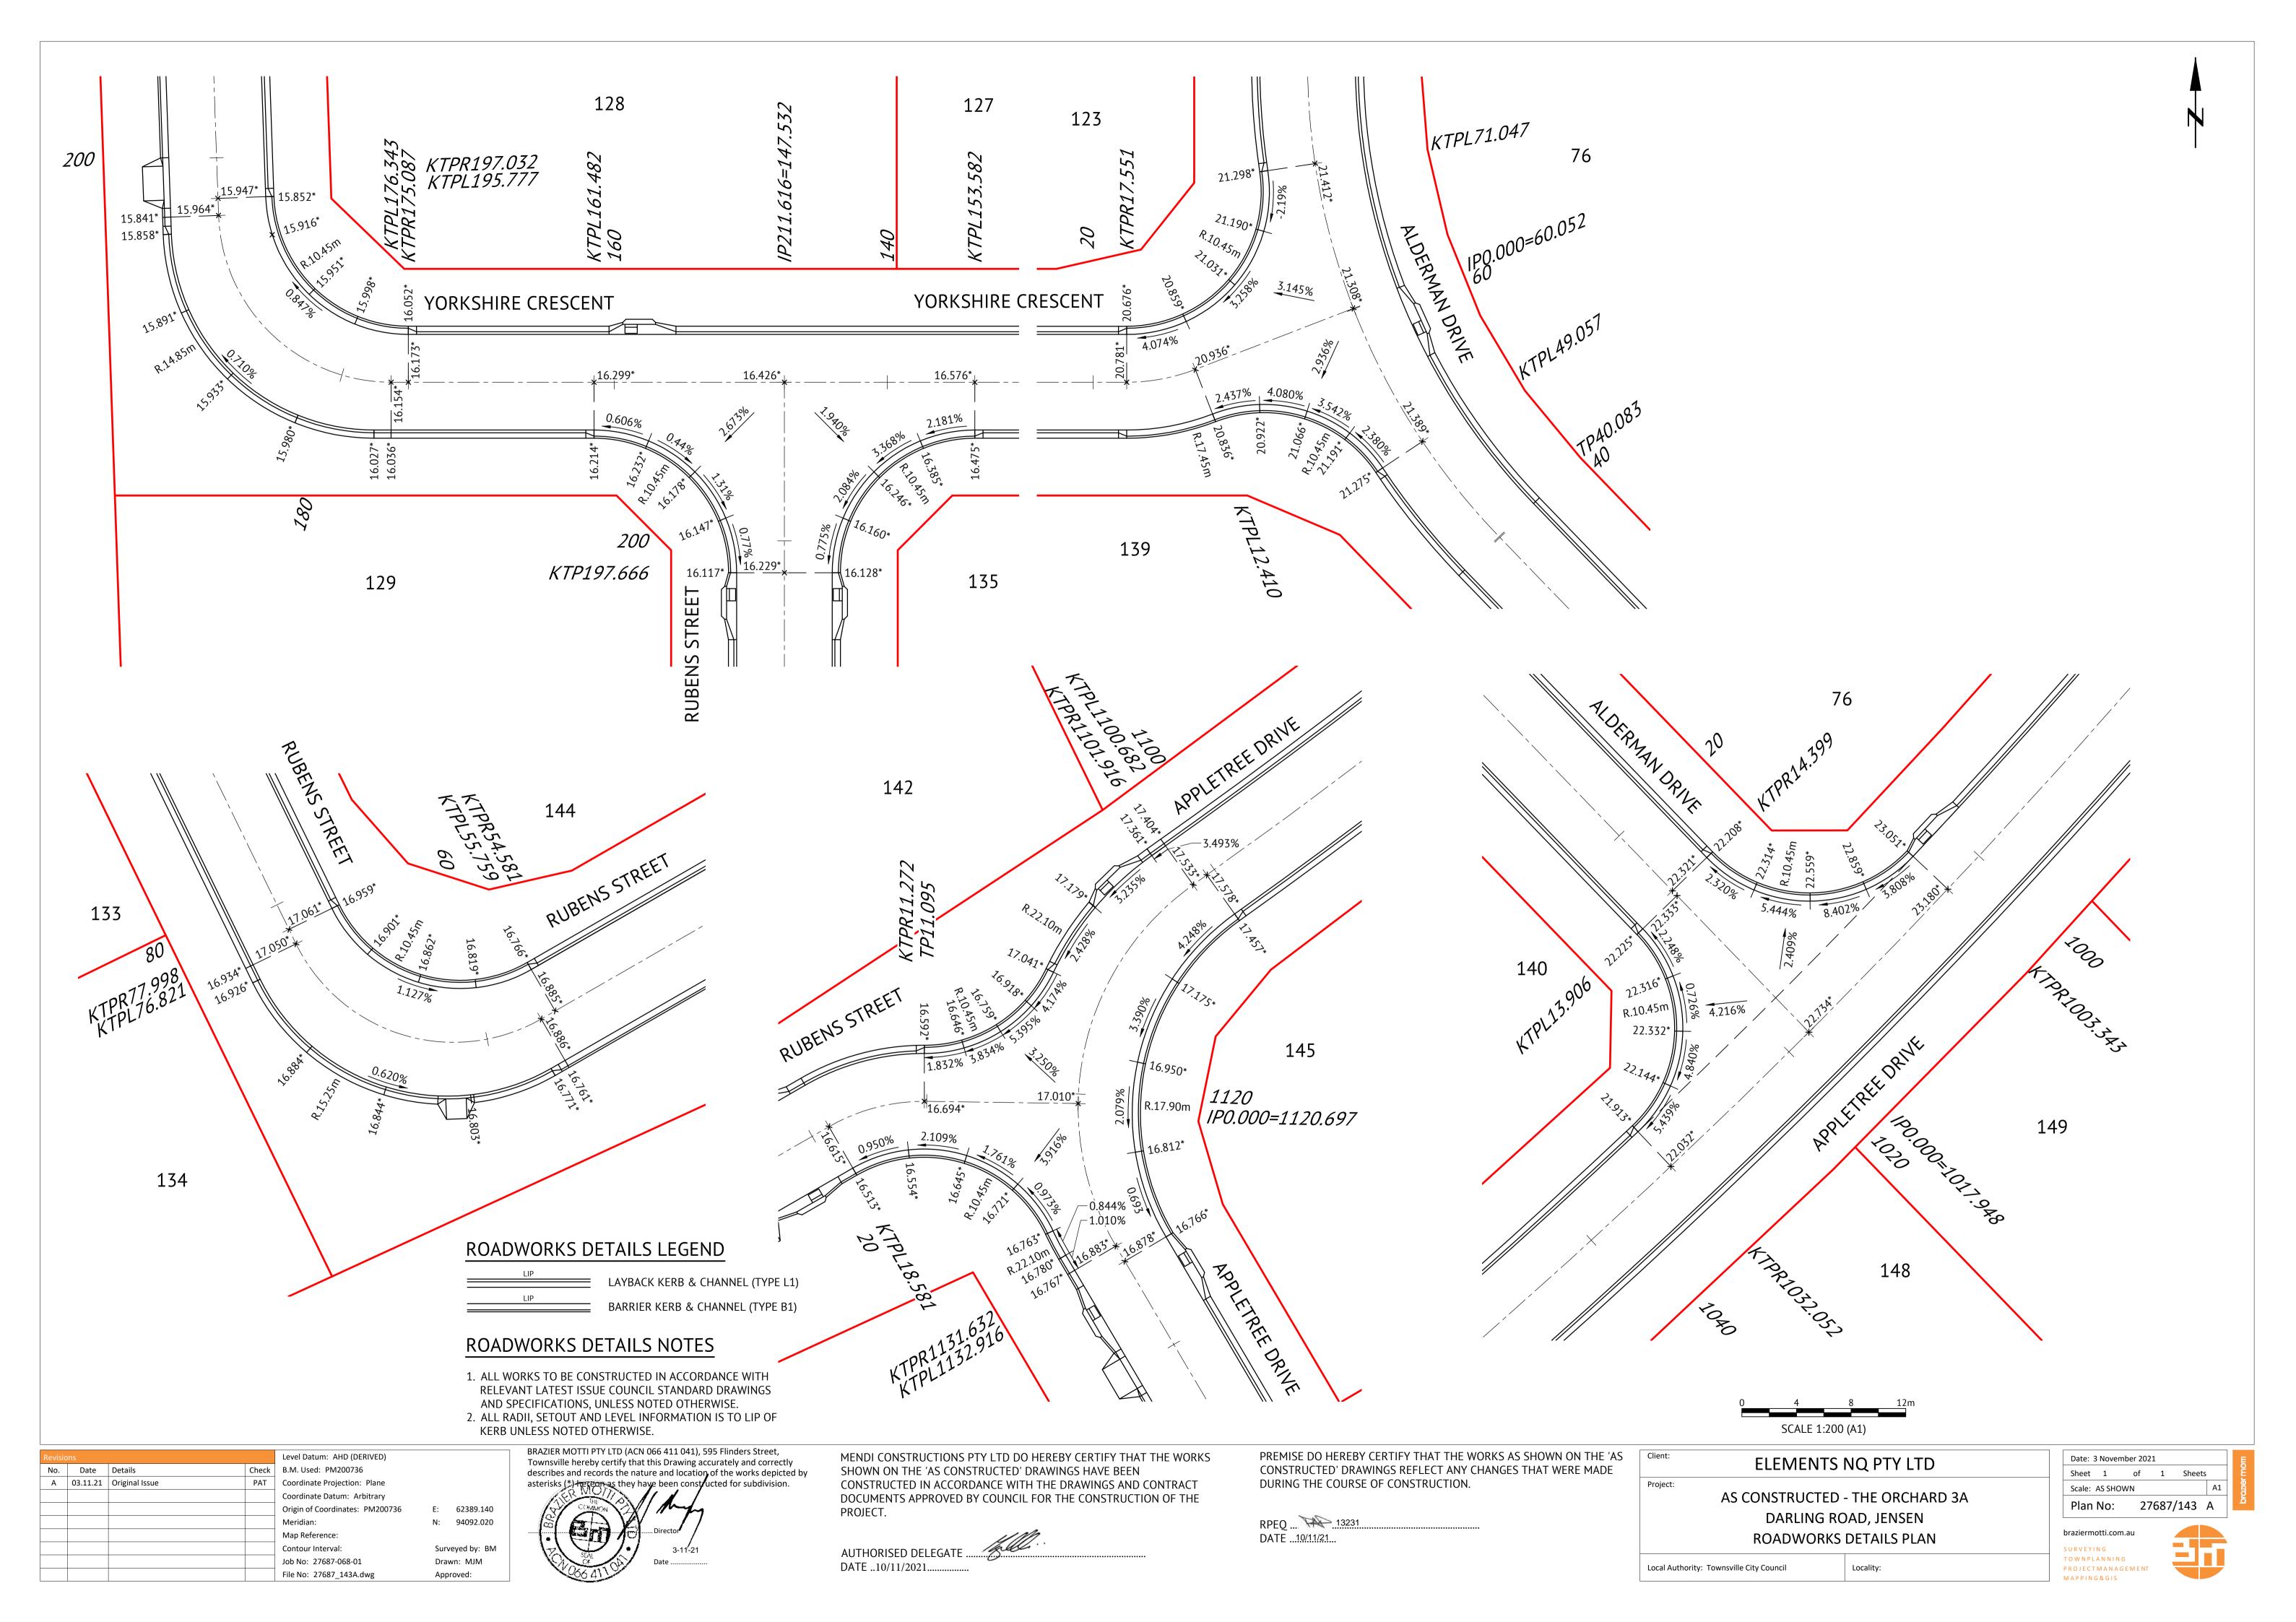

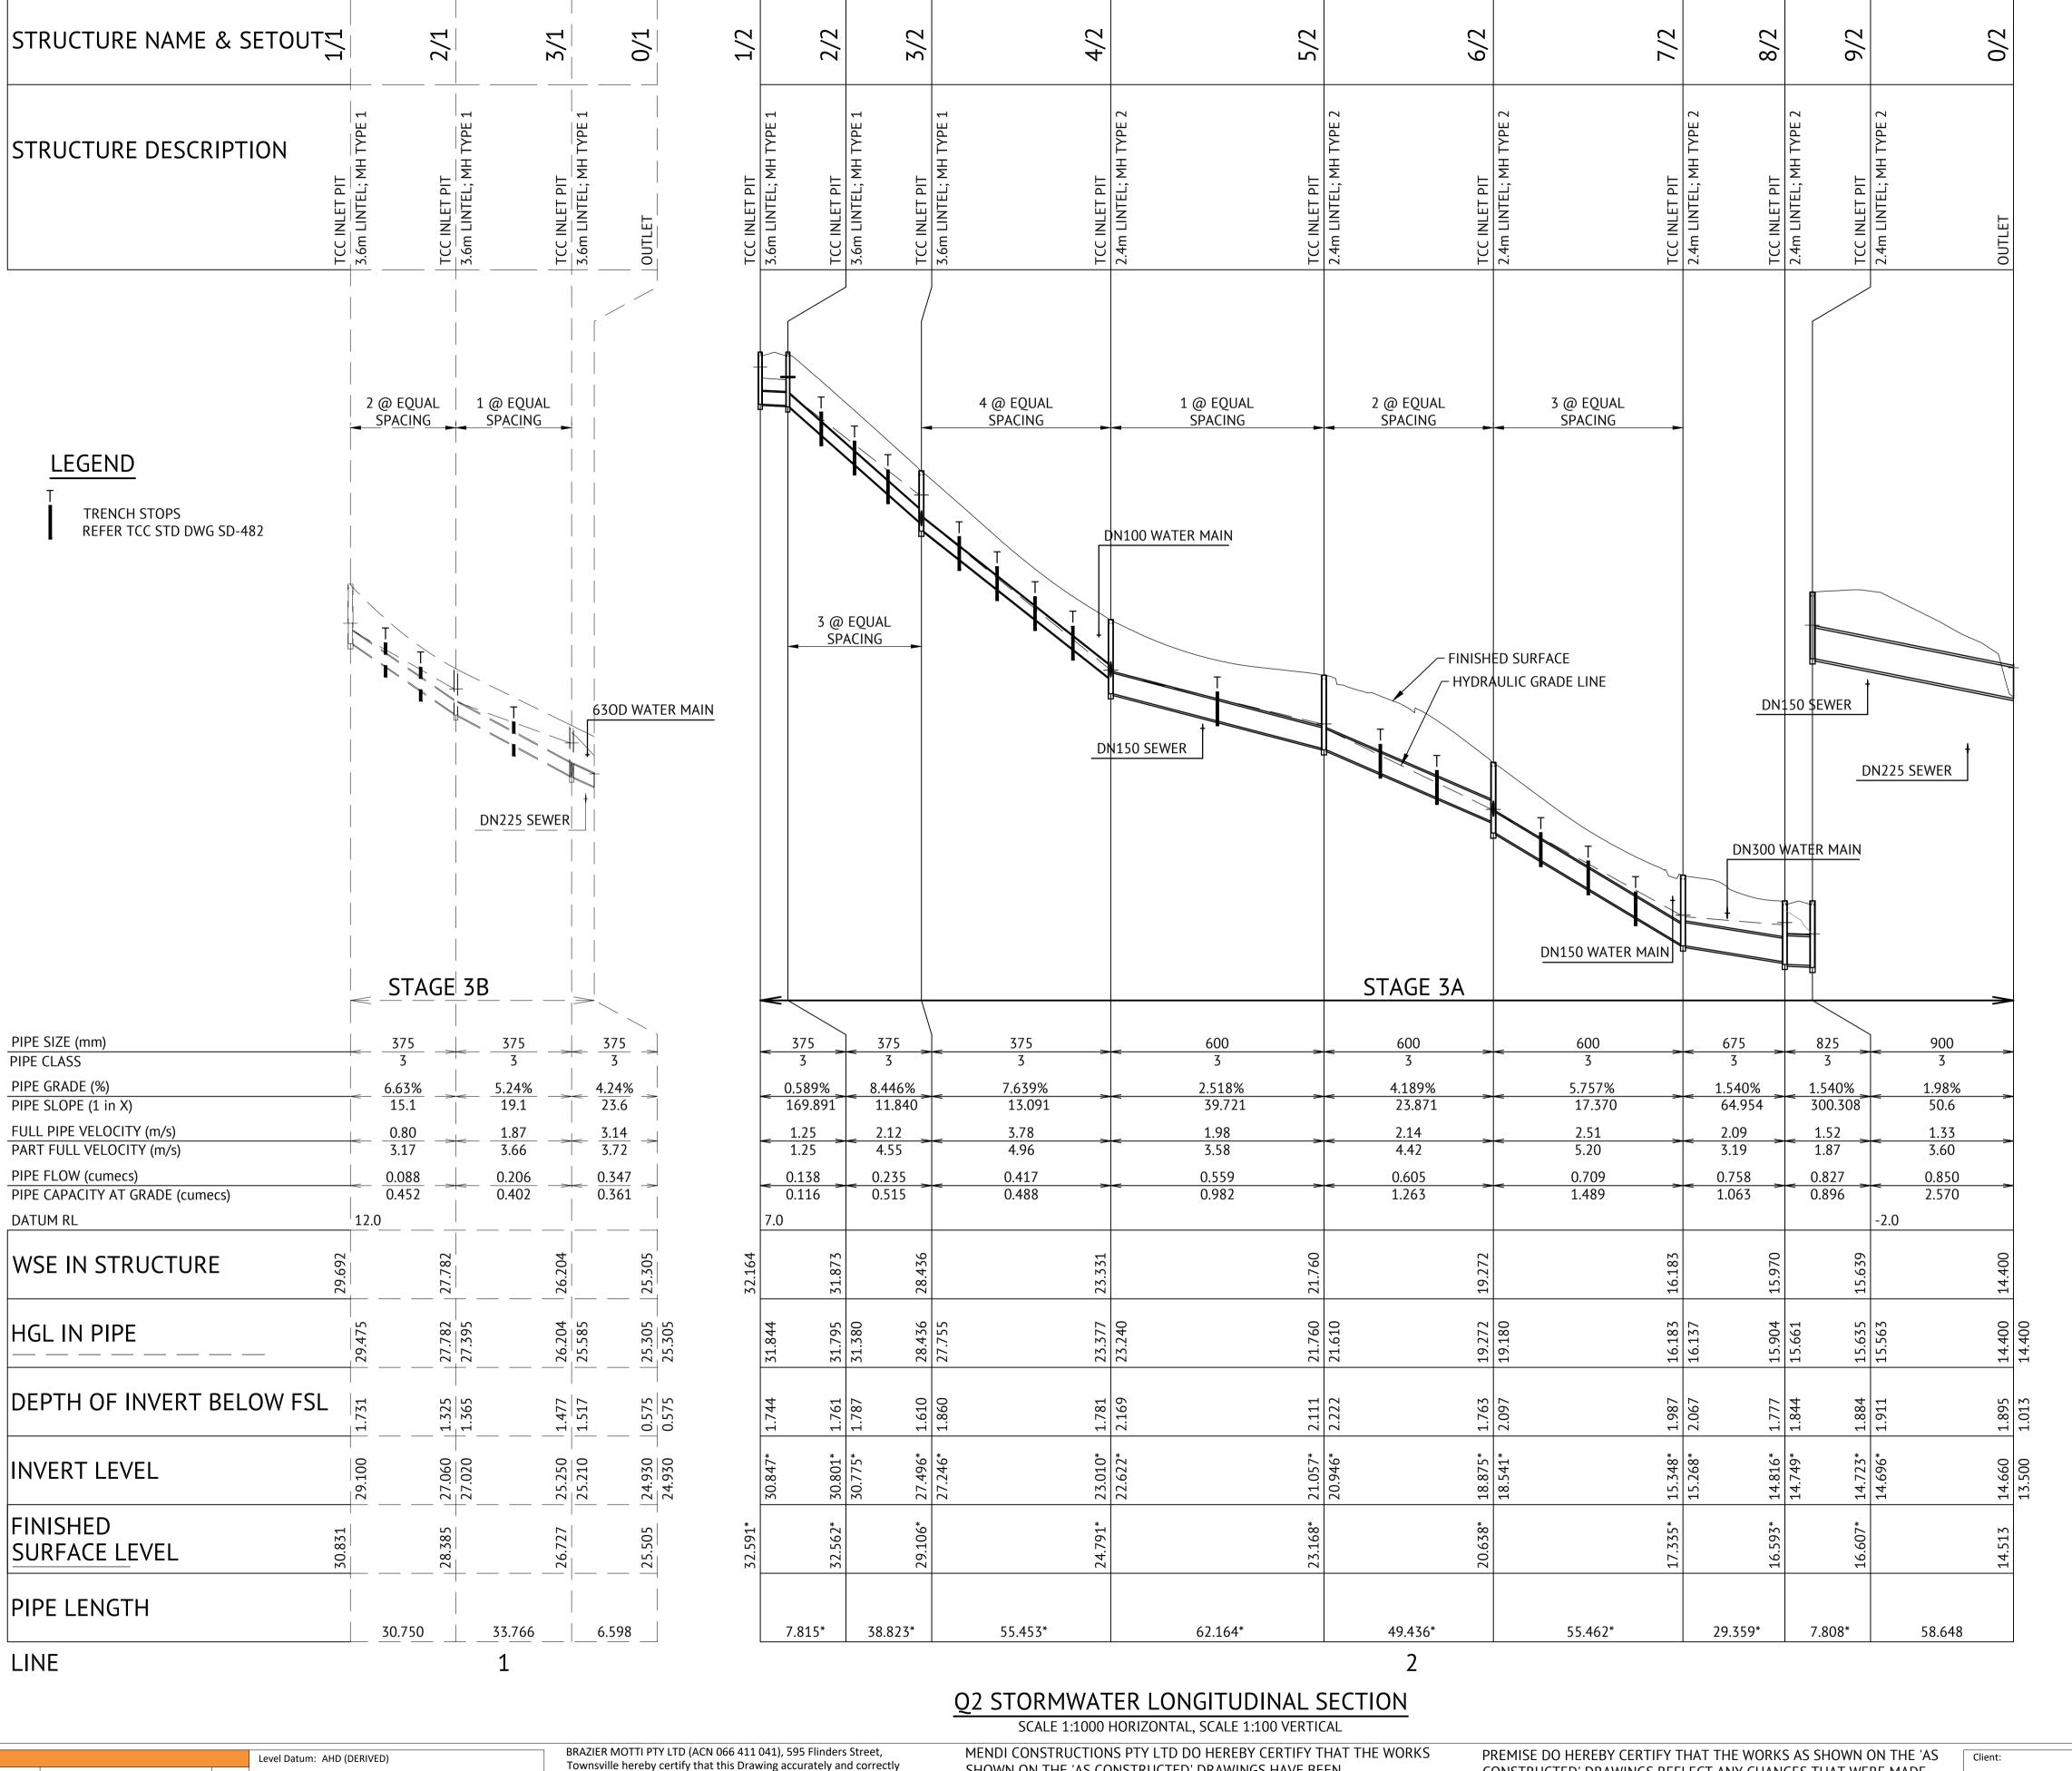

STORMWATER NOTES


- 1. ALL WORKS CONSTRUCTED IN ACCORDANCE WITH THE RELEVANT LATEST ISSUE COUNCIL STANDARD DRAWINGS AND SPECIFICATIONS, UNLESS NOTED OTHERWISE,
- 2. STRUCTURE SETOUT FOR ALL PRECAST GRATED KERB INLETS (TYPE 1 & 2) IS TO THE CENTRE OF THE GRATE AND 530mm FROM THE LIP OF KERB.
- 3. ALL RCP DRAINAGE PIPES FLUSH JOINTED WITH EXTERNAL
- RUBBER BAND, UNLESS NOTED OTHERWISE. 4. ALL uPVC DRAINAGE PIPES RUBBER RING JOINTED
- CONFORMING TO AS1254. 5. ALL POLYPROPYLENE DRAINAGE PIPES IN ACCORDANCE WITH
- AS5065. 6. PIPE CLASS: (2) - RCP CLASS 2
 - (3) RCP CLASS 3
 - (4) RCP CLASS 4
 - (6) RCP CLASS 6
 - (8) RCP CLASS 8
 - (P) POLYPROPYLENE
 - (U) uPVC


(RCBC) - BOX CULVERT

PROVIDE 3/N12 GALVANISED DOWEL BARS-300mm LONG TO EACH SIDE OF THE KERB TRANSITIONS. **ENSURE 100mm EMBEDMENT AND EPOXY** GROUTED INTO KERB AND CHANNEL AND PRECAST KERB INLET ENTRY UNIT PRECAST CONCRETE KERB INLET ENTRY UNIT STRUCTURE **SETOUT** FOR KERB TRANSITION DETAILS REFER COUNCIL STANDARD DRAWING SD-200

KERB INLET TRANSITION DETAIL

SCALE 1:50

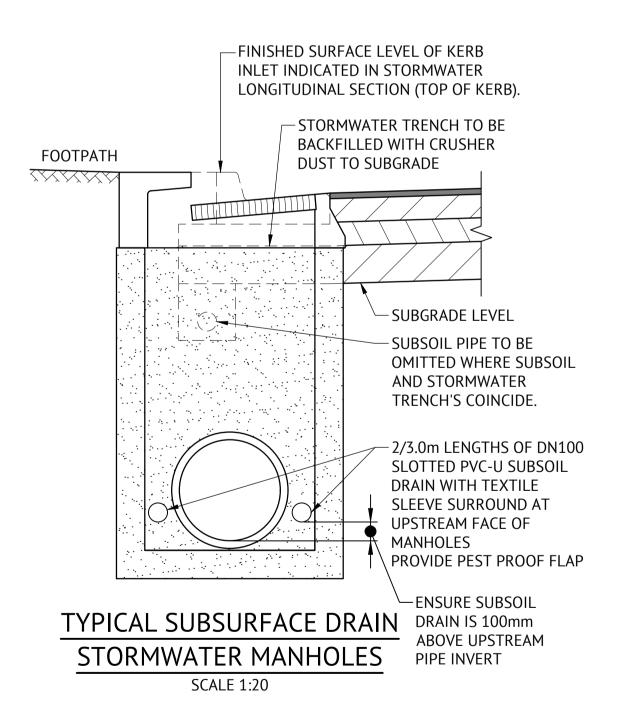

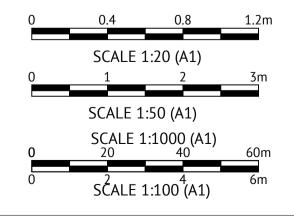

SHOWN ON THE 'AS CONSTRUCTED' DRAWINGS HAVE BEEN CONSTRUCTED IN ACCORDANCE WITH THE DRAWINGS AND CONTRACT DOCUMENTS APPROVED BY COUNCIL FOR THE CONSTRUCTION OF THE

AUTHORISED DELEGATE .. DATE ..10/11/2021.....

CONSTRUCTED' DRAWINGS REFLECT ANY CHANGES THAT WERE MADE DURING THE COURSE OF CONSTRUCTION.

RPEQ ... 13231 DATE ..10/11/21..

ELEMENTS NQ PTY LTD

AS CONSTRUCTED - THE ORCHARD 3A DARLING ROAD, JENSEN

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Scale: AS SHOWN

Plan No:

MAPPING&GIS

Date: 3 November 2021



27687/144 A

A1

N: 94092.020 Meridian: Map Reference: Contour Interval: Surveyed by: BM Job No: 27687-068-01 Drawn: MJM

B.M. Used: PM200736

Coordinate Projection: Plane

Coordinate Datum: Arbitrary

File No: 27687_144A.dwg

Origin of Coordinates: PM200736

62389.140

Approved:

Date Details

A 03.11.21 Original Issue


asterisks (*) bereon as they have been constructed for subdivision.


describes and records the nature and location of the works depicted by


PROJECT.

Q2 STORMWATER LONGITUDINAL SECTION - SHEET 1 OF 2 Locality: Local Authority: Townsville City Council

Project:

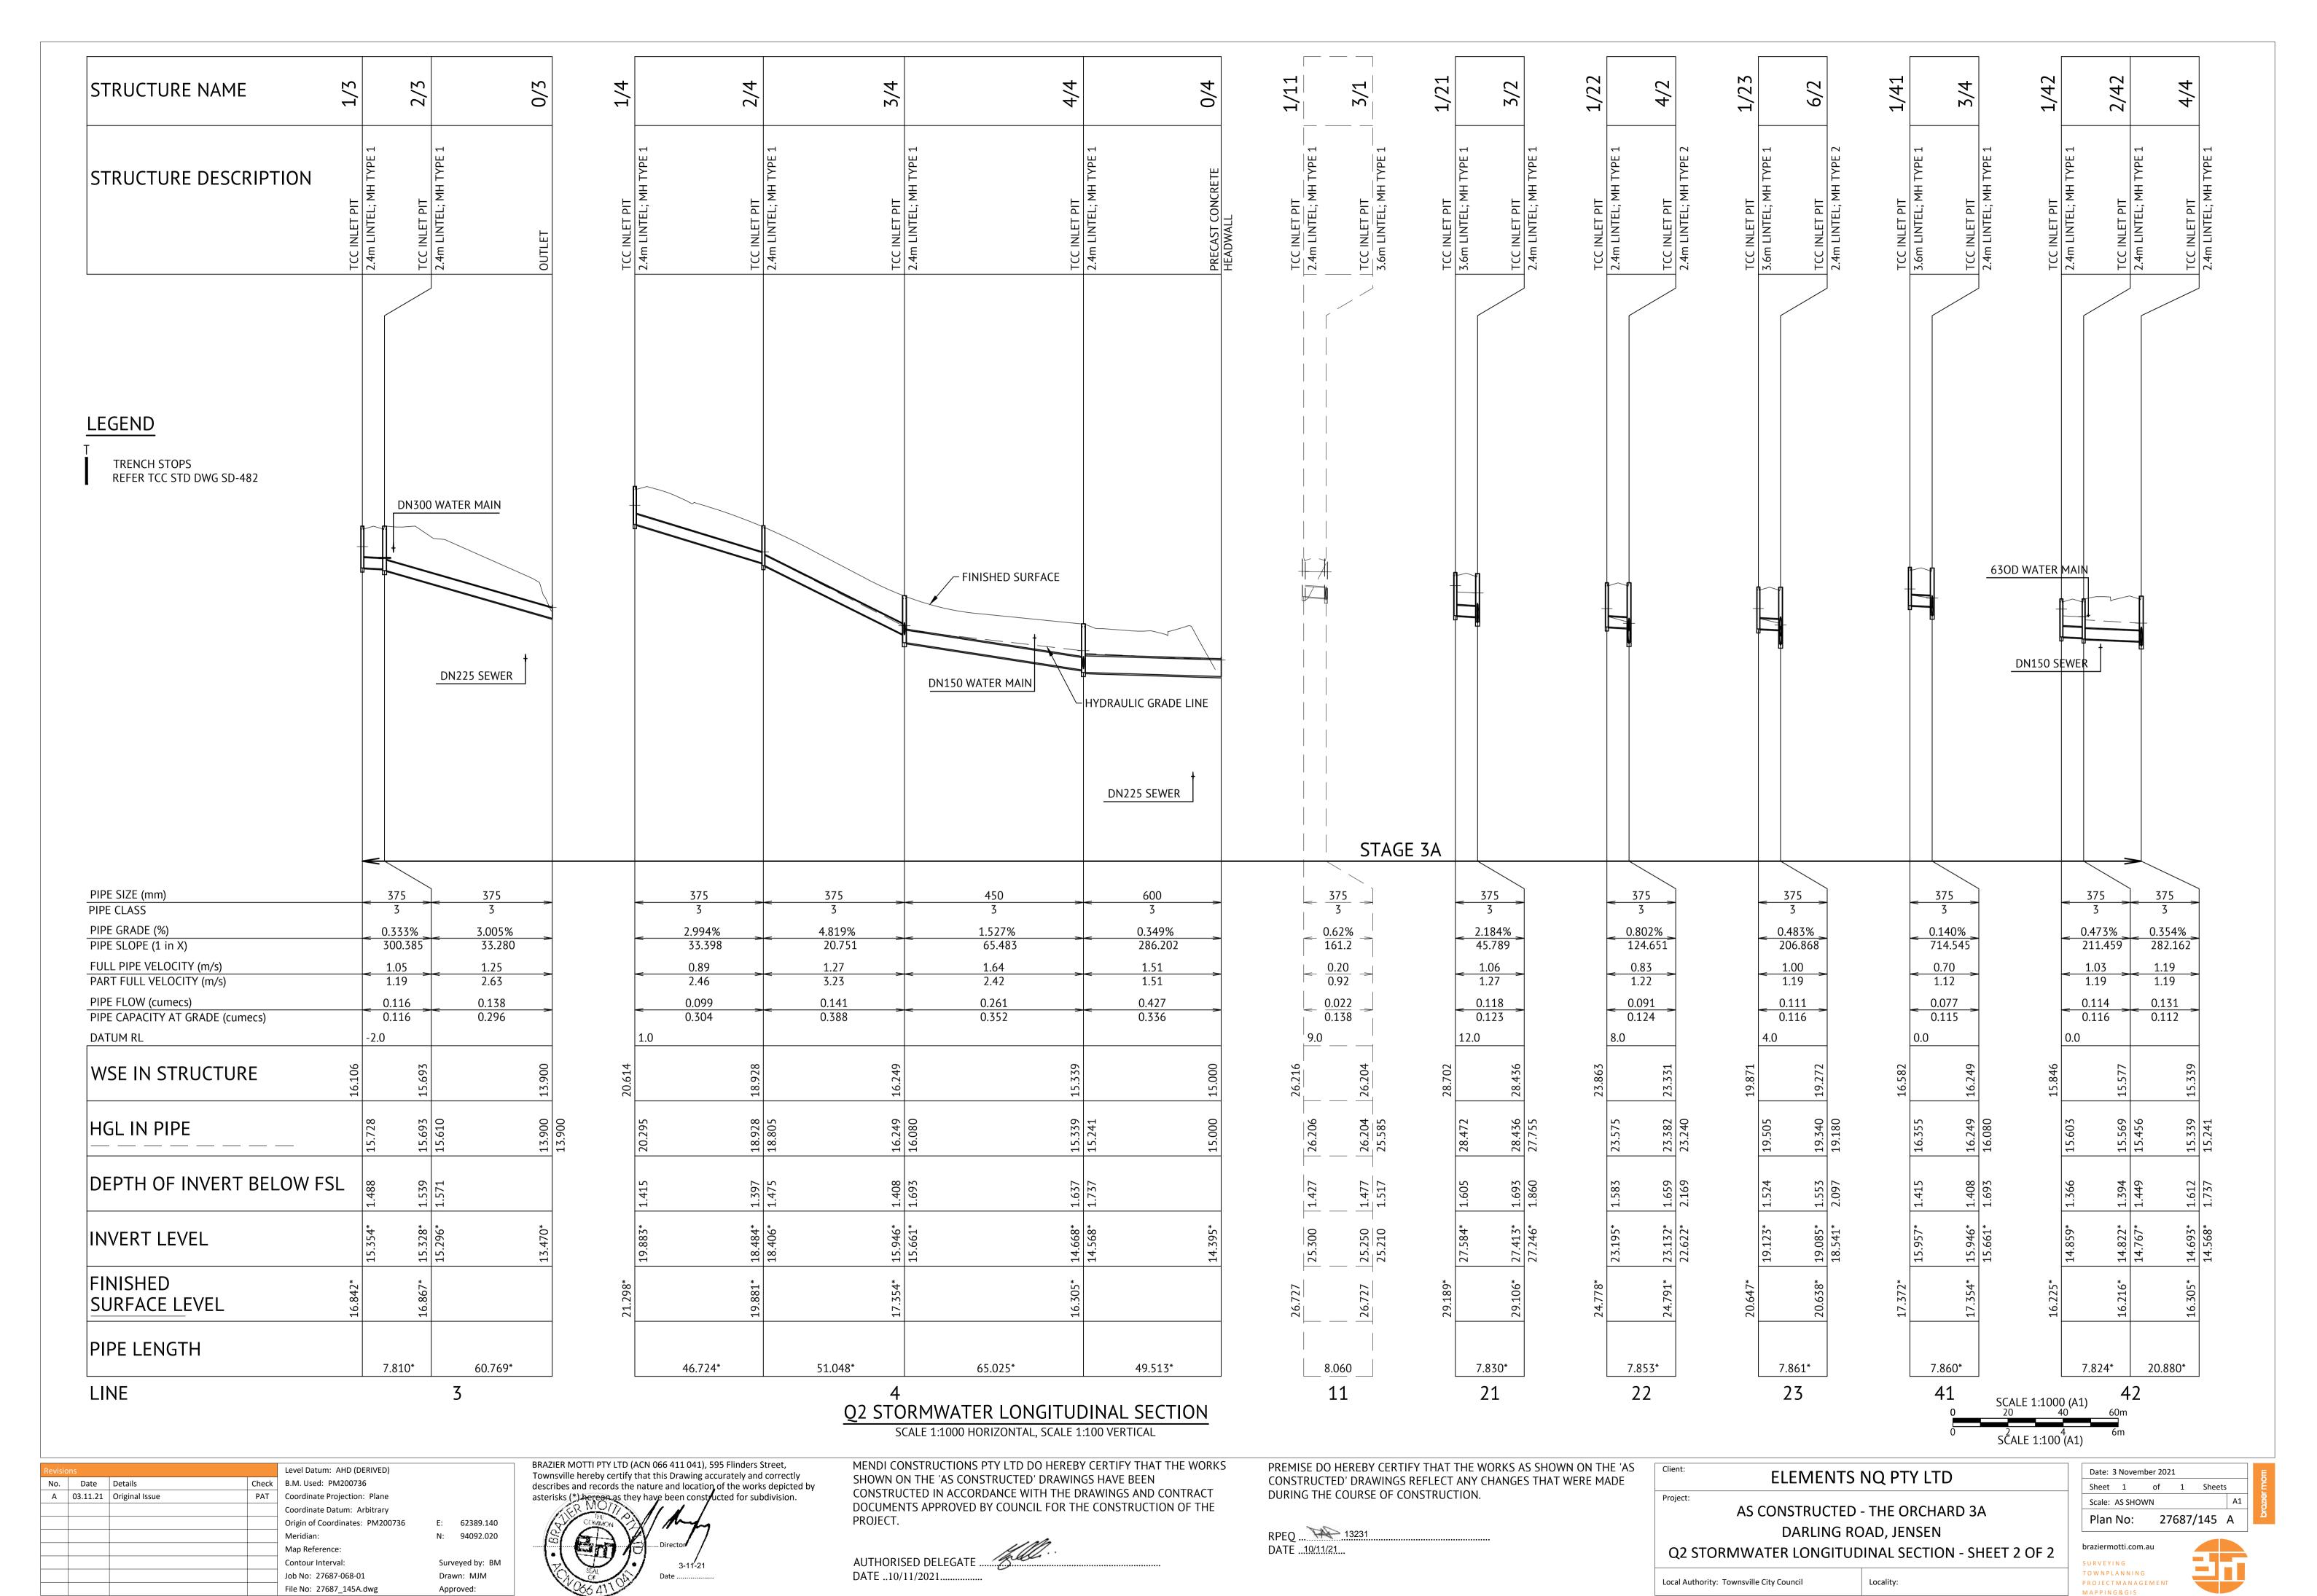

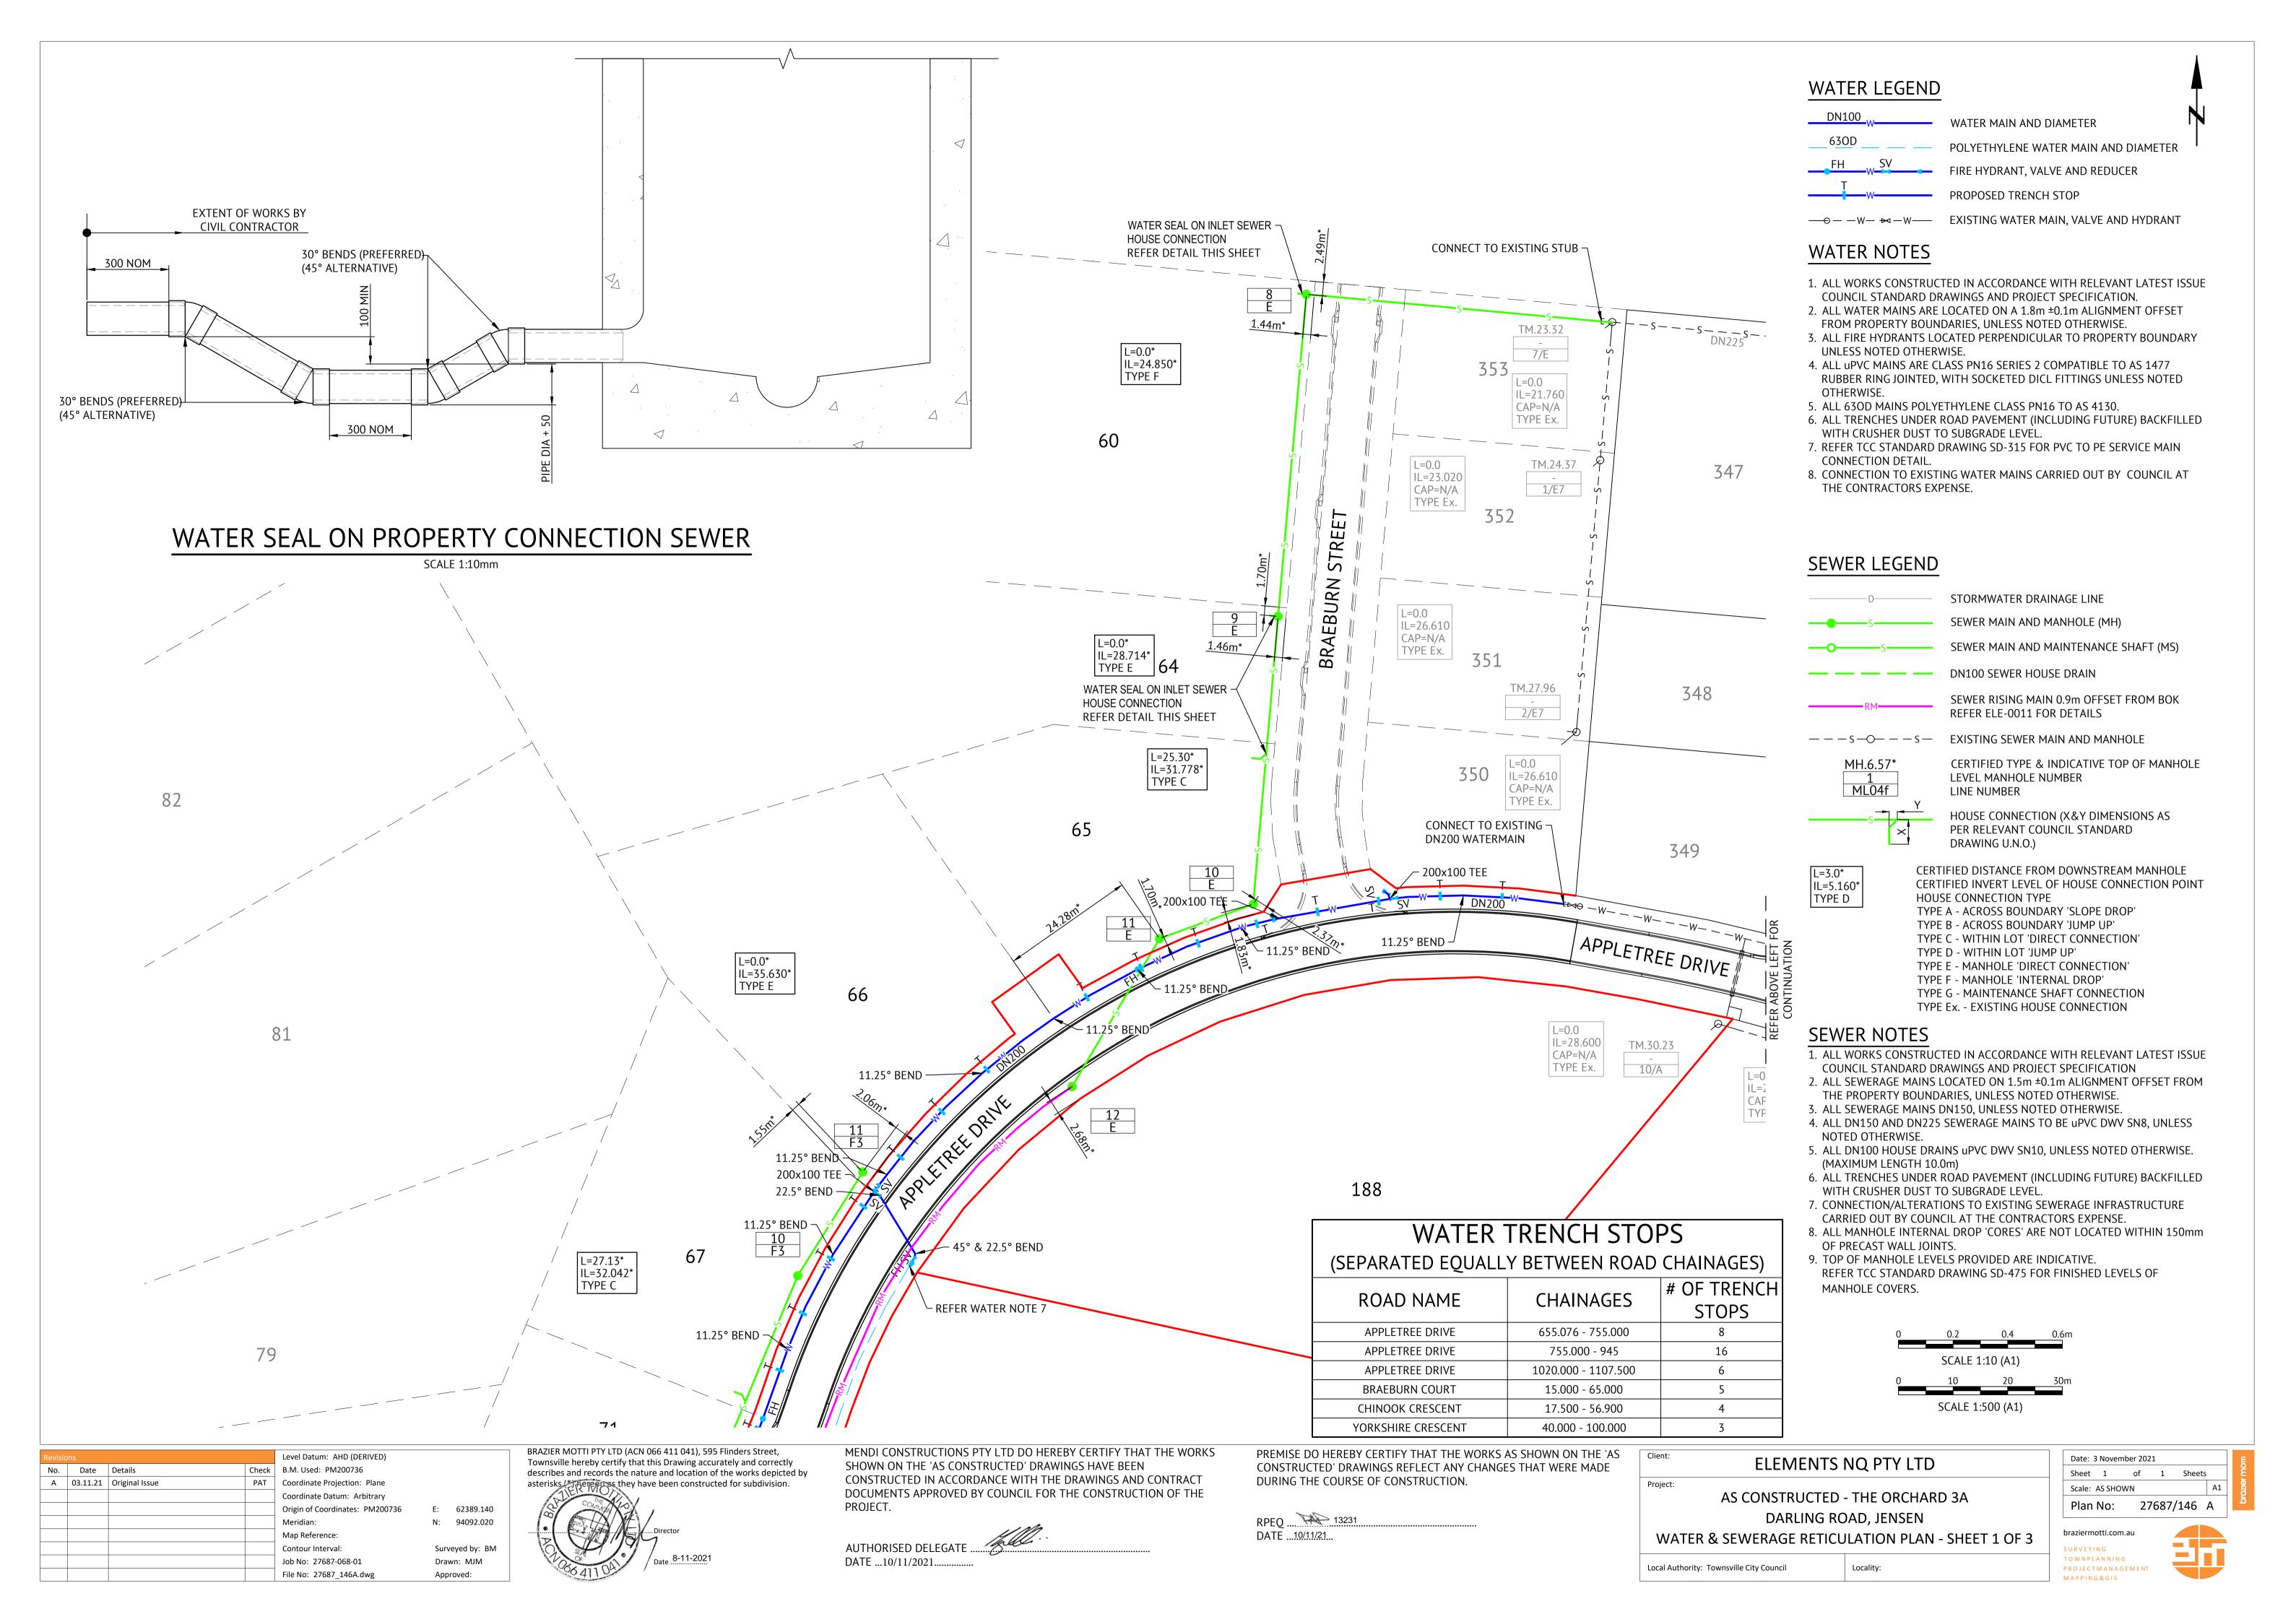

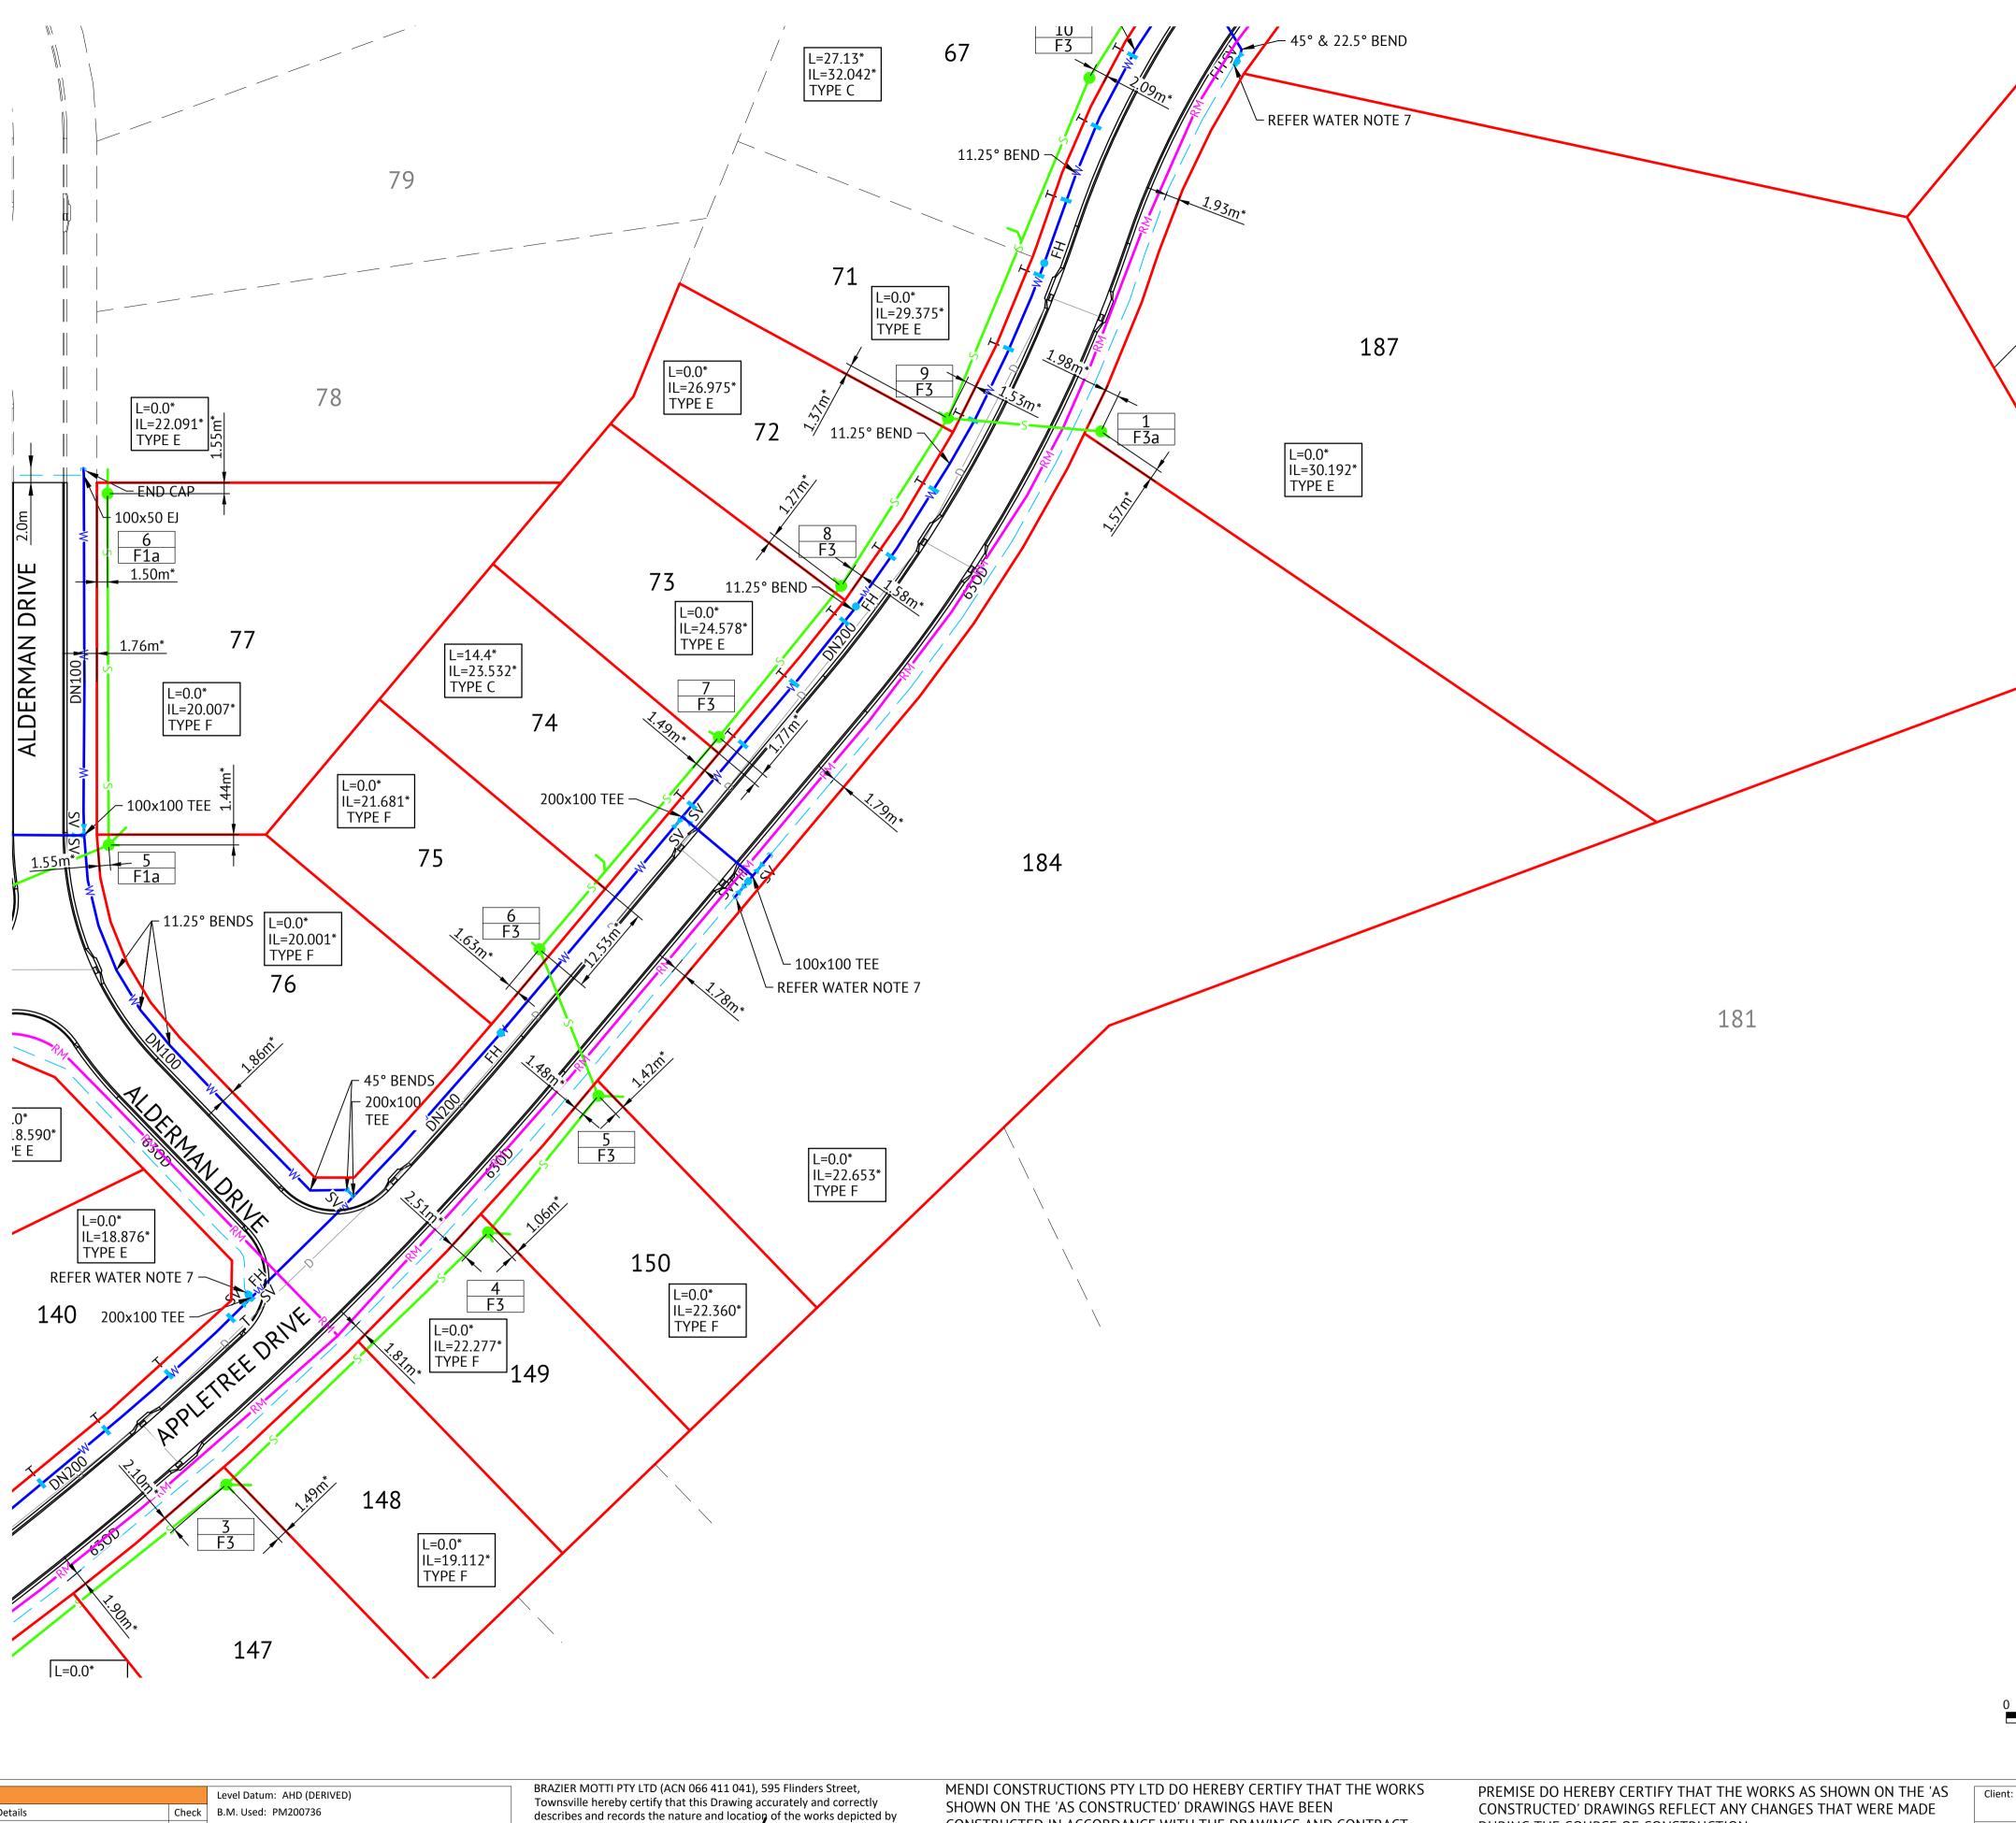

CONSTRUCTED IN ACCORDANCE WITH THE DRAWINGS AND CONTRACT

DOCUMENTS APPROVED BY COUNCIL FOR THE CONSTRUCTION OF THE

PROJECT.

AUTHORISED DELEGATE ...

DATE ...10/11/2021.....

PAT Coordinate Projection: Plane

Meridian:

Map Reference:

Contour Interval:

Job No: 27687-068-01

File No: 27687_147A.dwg

Coordinate Datum: Arbitrary

Origin of Coordinates: PM200736

62389.140

N: 94092.020

Surveyed by: BM

Drawn: MJM

Approved:

asterisks (*) hereon as they have been constructed for subdivision.

A 03.11.21 Original Issue

CONSTRUCTED' DRAWINGS REFLECT ANY CHANGES THAT WERE MADE DURING THE COURSE OF CONSTRUCTION.

RPEQ ... 13231 DATE ...10/11/21...

ELEMENTS NQ PTY LTD

191

WATER LEGEND

WATER NOTES

OTHERWISE.

CONNECTION DETAIL.

SEWER LEGEND

MH.6.57*

SEWER NOTES

NOTED OTHERWISE.

(MAXIMUM LENGTH 10.0m)

OF PRECAST WALL JOINTS.

MANHOLE COVERS.

WITH CRUSHER DUST TO SUBGRADE LEVEL.

IL=5.160* TYPE D

THE CONTRACTORS EXPENSE.

UNLESS NOTED OTHERWISE.

WATER MAIN AND DIAMETER

PROPOSED TRENCH STOP

— O — W — W — W — EXISTING WATER MAIN, VALVE AND HYDRANT

1. ALL WORKS CONSTRUCTED IN ACCORDANCE WITH RELEVANT LATEST ISSUE

2. ALL WATER MAINS ARE LOCATED ON A 1.8m ±0.1m ALIGNMENT OFFSET

4. ALL uPVC MAINS ARE CLASS PN16 SERIES 2 COMPATIBLE TO AS 1477

3. ALL FIRE HYDRANTS LOCATED PERPENDICULAR TO PROPERTY BOUNDARY

RUBBER RING JOINTED, WITH SOCKETED DICL FITTINGS UNLESS NOTED

6. ALL TRENCHES UNDER ROAD PAVEMENT (INCLUDING FUTURE) BACKFILLED

7. REFER TCC STANDARD DRAWING SD-315 FOR PVC TO PE SERVICE MAIN

8. CONNECTION TO EXISTING WATER MAINS CARRIED OUT BY COUNCIL AT

STORMWATER DRAINAGE LINE

DN100 SEWER HOUSE DRAIN

REFER ELE-0011 FOR DETAILS

LEVEL MANHOLE NUMBER

— — S — O— — — S — EXISTING SEWER MAIN AND MANHOLE

LINE NUMBER

DRAWING U.N.O.)

HOUSE CONNECTION TYPE

TYPE D - WITHIN LOT 'JUMP UP'

SEWER MAIN AND MANHOLE (MH)

SEWER MAIN AND MAINTENANCE SHAFT (MS)

SEWER RISING MAIN 0.9m OFFSET FROM BOK

CERTIFIED TYPE & INDICATIVE TOP OF MANHOLE

HOUSE CONNECTION (X&Y DIMENSIONS AS

PER RELEVANT COUNCIL STANDARD

TYPE A - ACROSS BOUNDARY 'SLOPE DROP' TYPE B - ACROSS BOUNDARY 'JUMP UP'

TYPE C - WITHIN LOT 'DIRECT CONNECTION'

TYPE G - MAINTENANCE SHAFT CONNECTION

TYPE E - MANHOLE 'DIRECT CONNECTION'

TYPE Ex. - EXISTING HOUSE CONNECTION

TYPE F - MANHOLE 'INTERNAL DROP'

1. ALL WORKS CONSTRUCTED IN ACCORDANCE WITH RELEVANT LATEST ISSUE

2. ALL SEWERAGE MAINS LOCATED ON 1.5m ±0.1m ALIGNMENT OFFSET FROM

4. ALL DN150 AND DN225 SEWERAGE MAINS TO BE uPVC DWV SN8, UNLESS

5. ALL DN100 HOUSE DRAINS uPVC DWV SN10, UNLESS NOTED OTHERWISE.

6. ALL TRENCHES UNDER ROAD PAVEMENT (INCLUDING FUTURE) BACKFILLED

8. ALL MANHOLE INTERNAL DROP 'CORES' ARE NOT LOCATED WITHIN 150mm

7. CONNECTION/ALTERATIONS TO EXISTING SEWERAGE INFRASTRUCTURE

REFER TCC STANDARD DRAWING SD-475 FOR FINISHED LEVELS OF

CARRIED OUT BY COUNCIL AT THE CONTRACTORS EXPENSE.

9. TOP OF MANHOLE LEVELS PROVIDED ARE INDICATIVE.

COUNCIL STANDARD DRAWINGS AND PROJECT SPECIFICATION

THE PROPERTY BOUNDARIES, UNLESS NOTED OTHERWISE. 3. ALL SEWERAGE MAINS DN150, UNLESS NOTED OTHERWISE.

CERTIFIED DISTANCE FROM DOWNSTREAM MANHOLE CERTIFIED INVERT LEVEL OF HOUSE CONNECTION POINT

COUNCIL STANDARD DRAWINGS AND PROJECT SPECIFICATION

FROM PROPERTY BOUNDARIES, UNLESS NOTED OTHERWISE.

5. ALL 630D MAINS POLYETHYLENE CLASS PN16 TO AS 4130.

WITH CRUSHER DUST TO SUBGRADE LEVEL.

POLYETHYLENE WATER MAIN AND DIAMETER

FIRE HYDRANT, VALVE AND REDUCER

DN100

AS CONSTRUCTED - THE ORCHARD 3A DARLING ROAD, JENSEN WATER & SEWERAGE RETICULATION PLAN - SHEET 2 OF 3

Plan No: 27687/147 A braziermotti.com.au TOWNPLANNING


Scale: AS SHOWN


Sheet 1 of 1 Sheets

Local Authority: Townsville City Council

SCALE 1:500 (A1)


Locality:

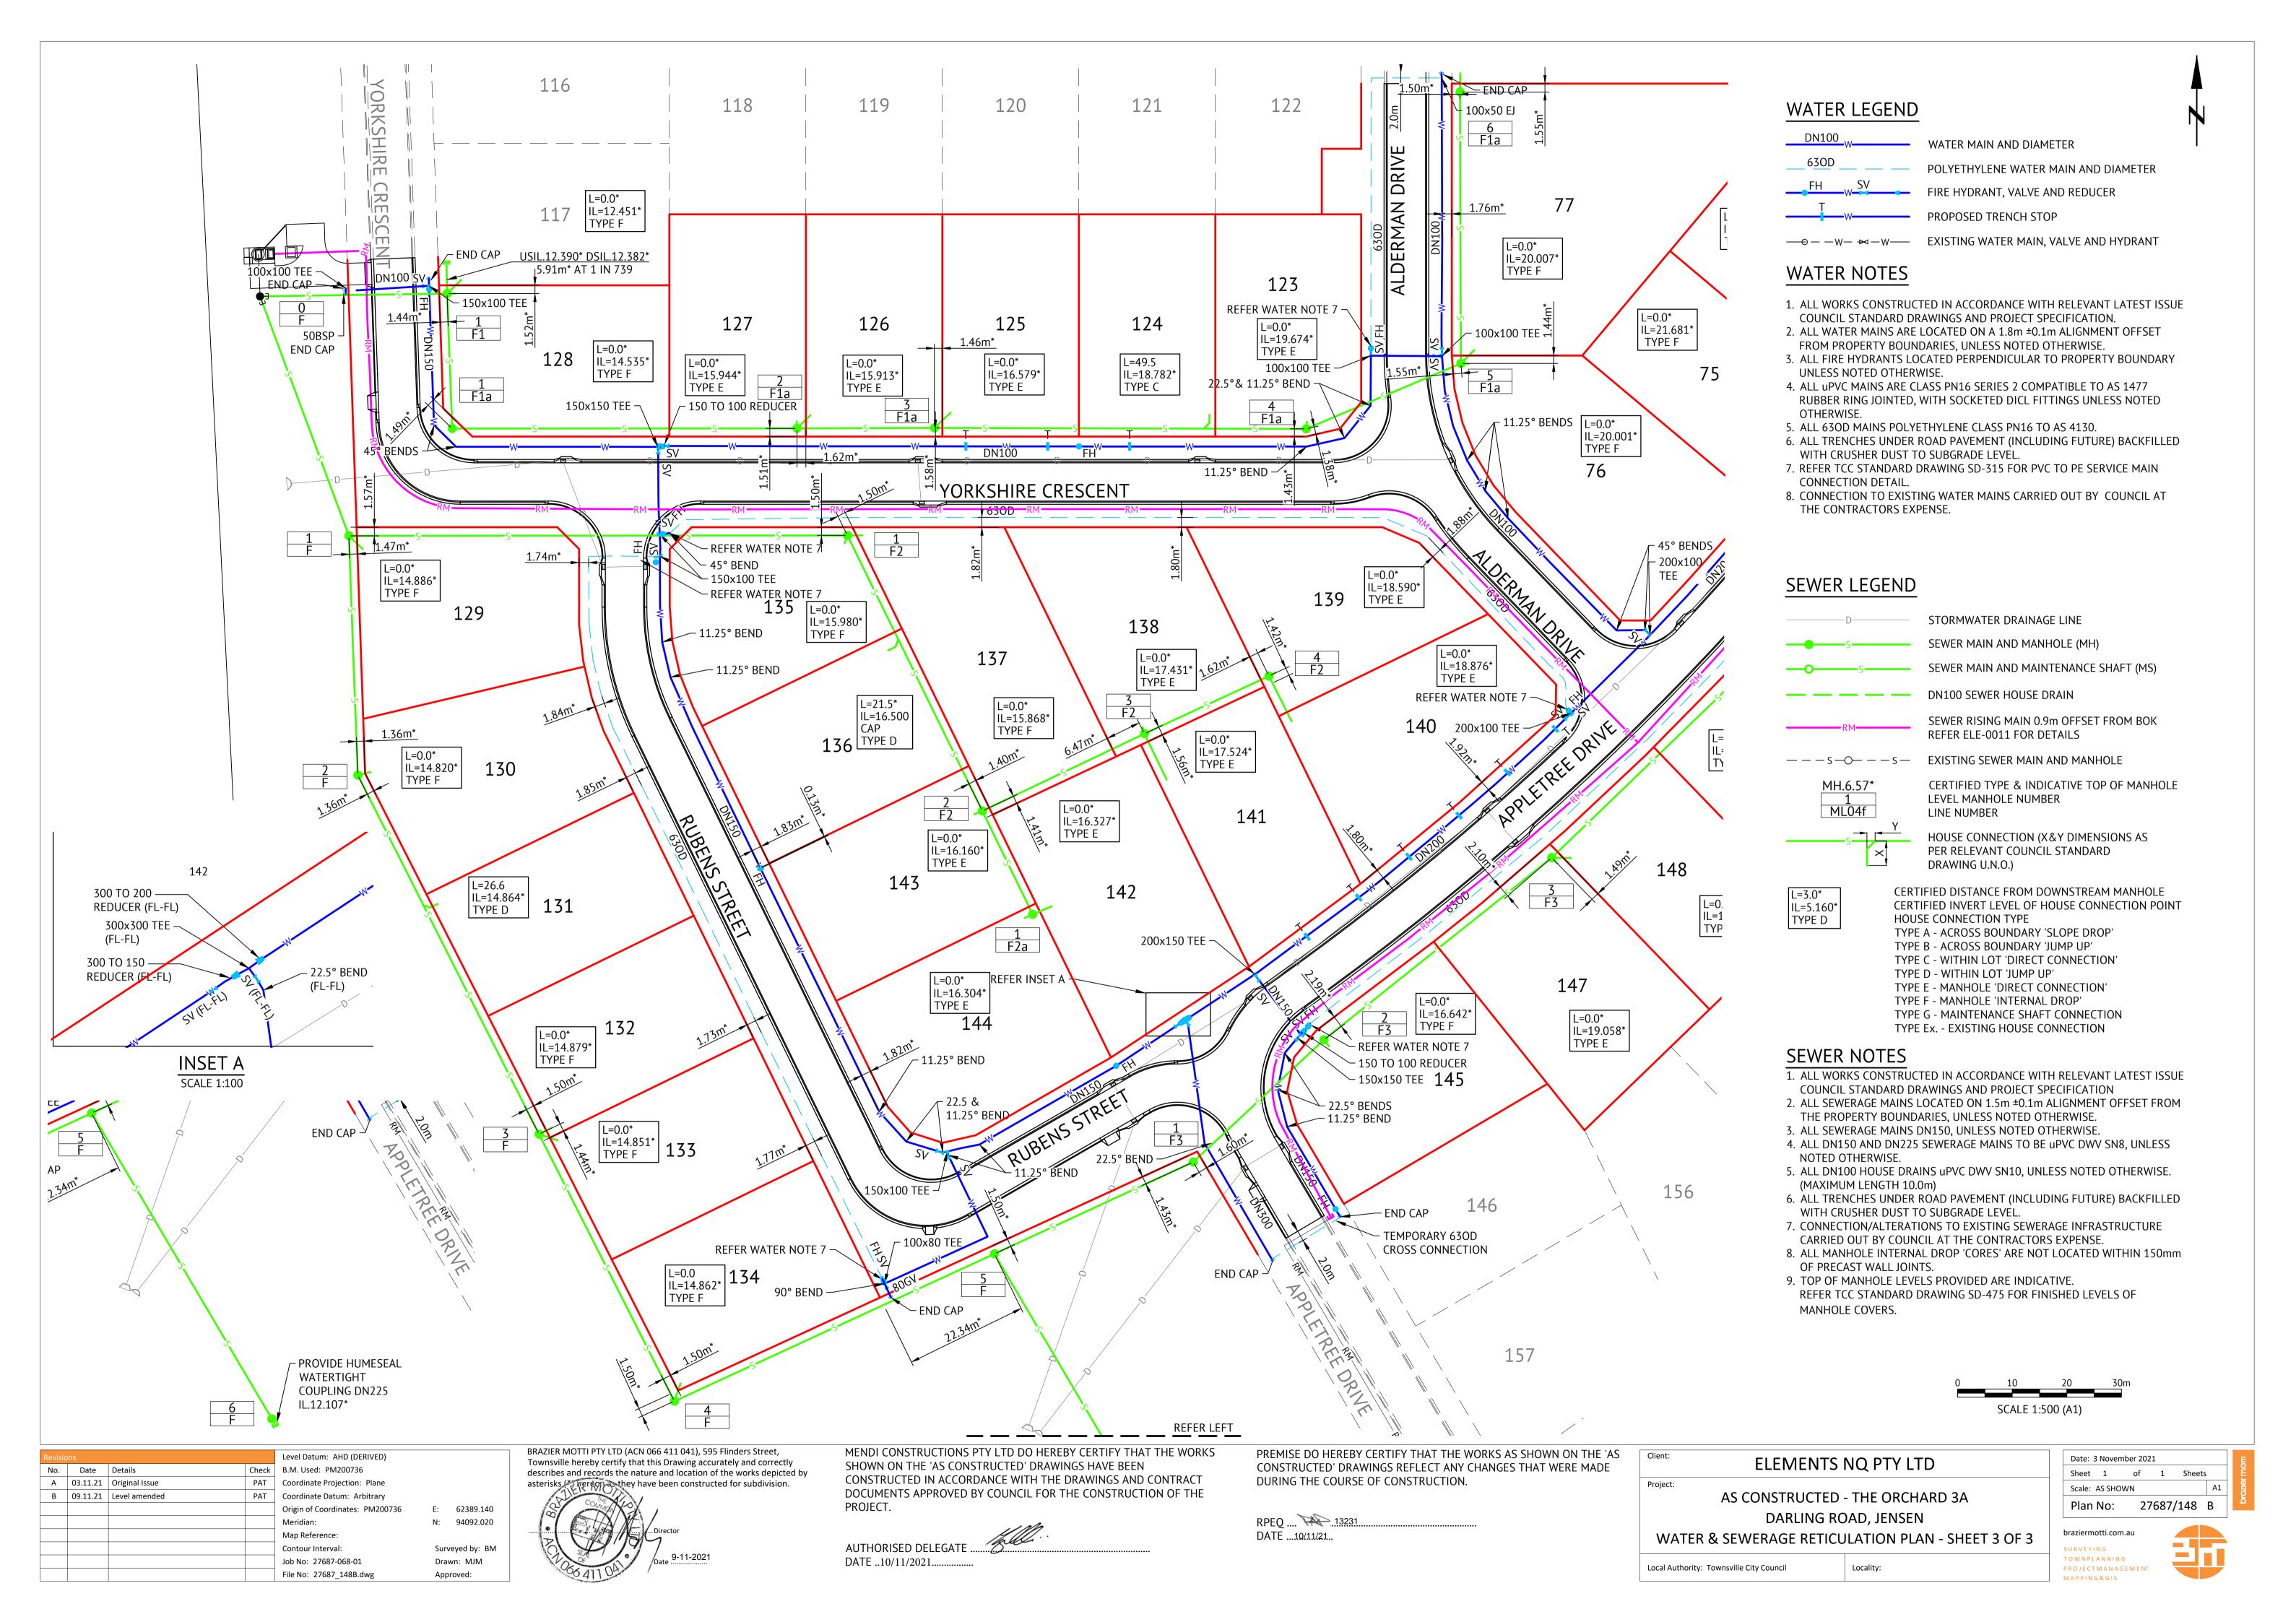

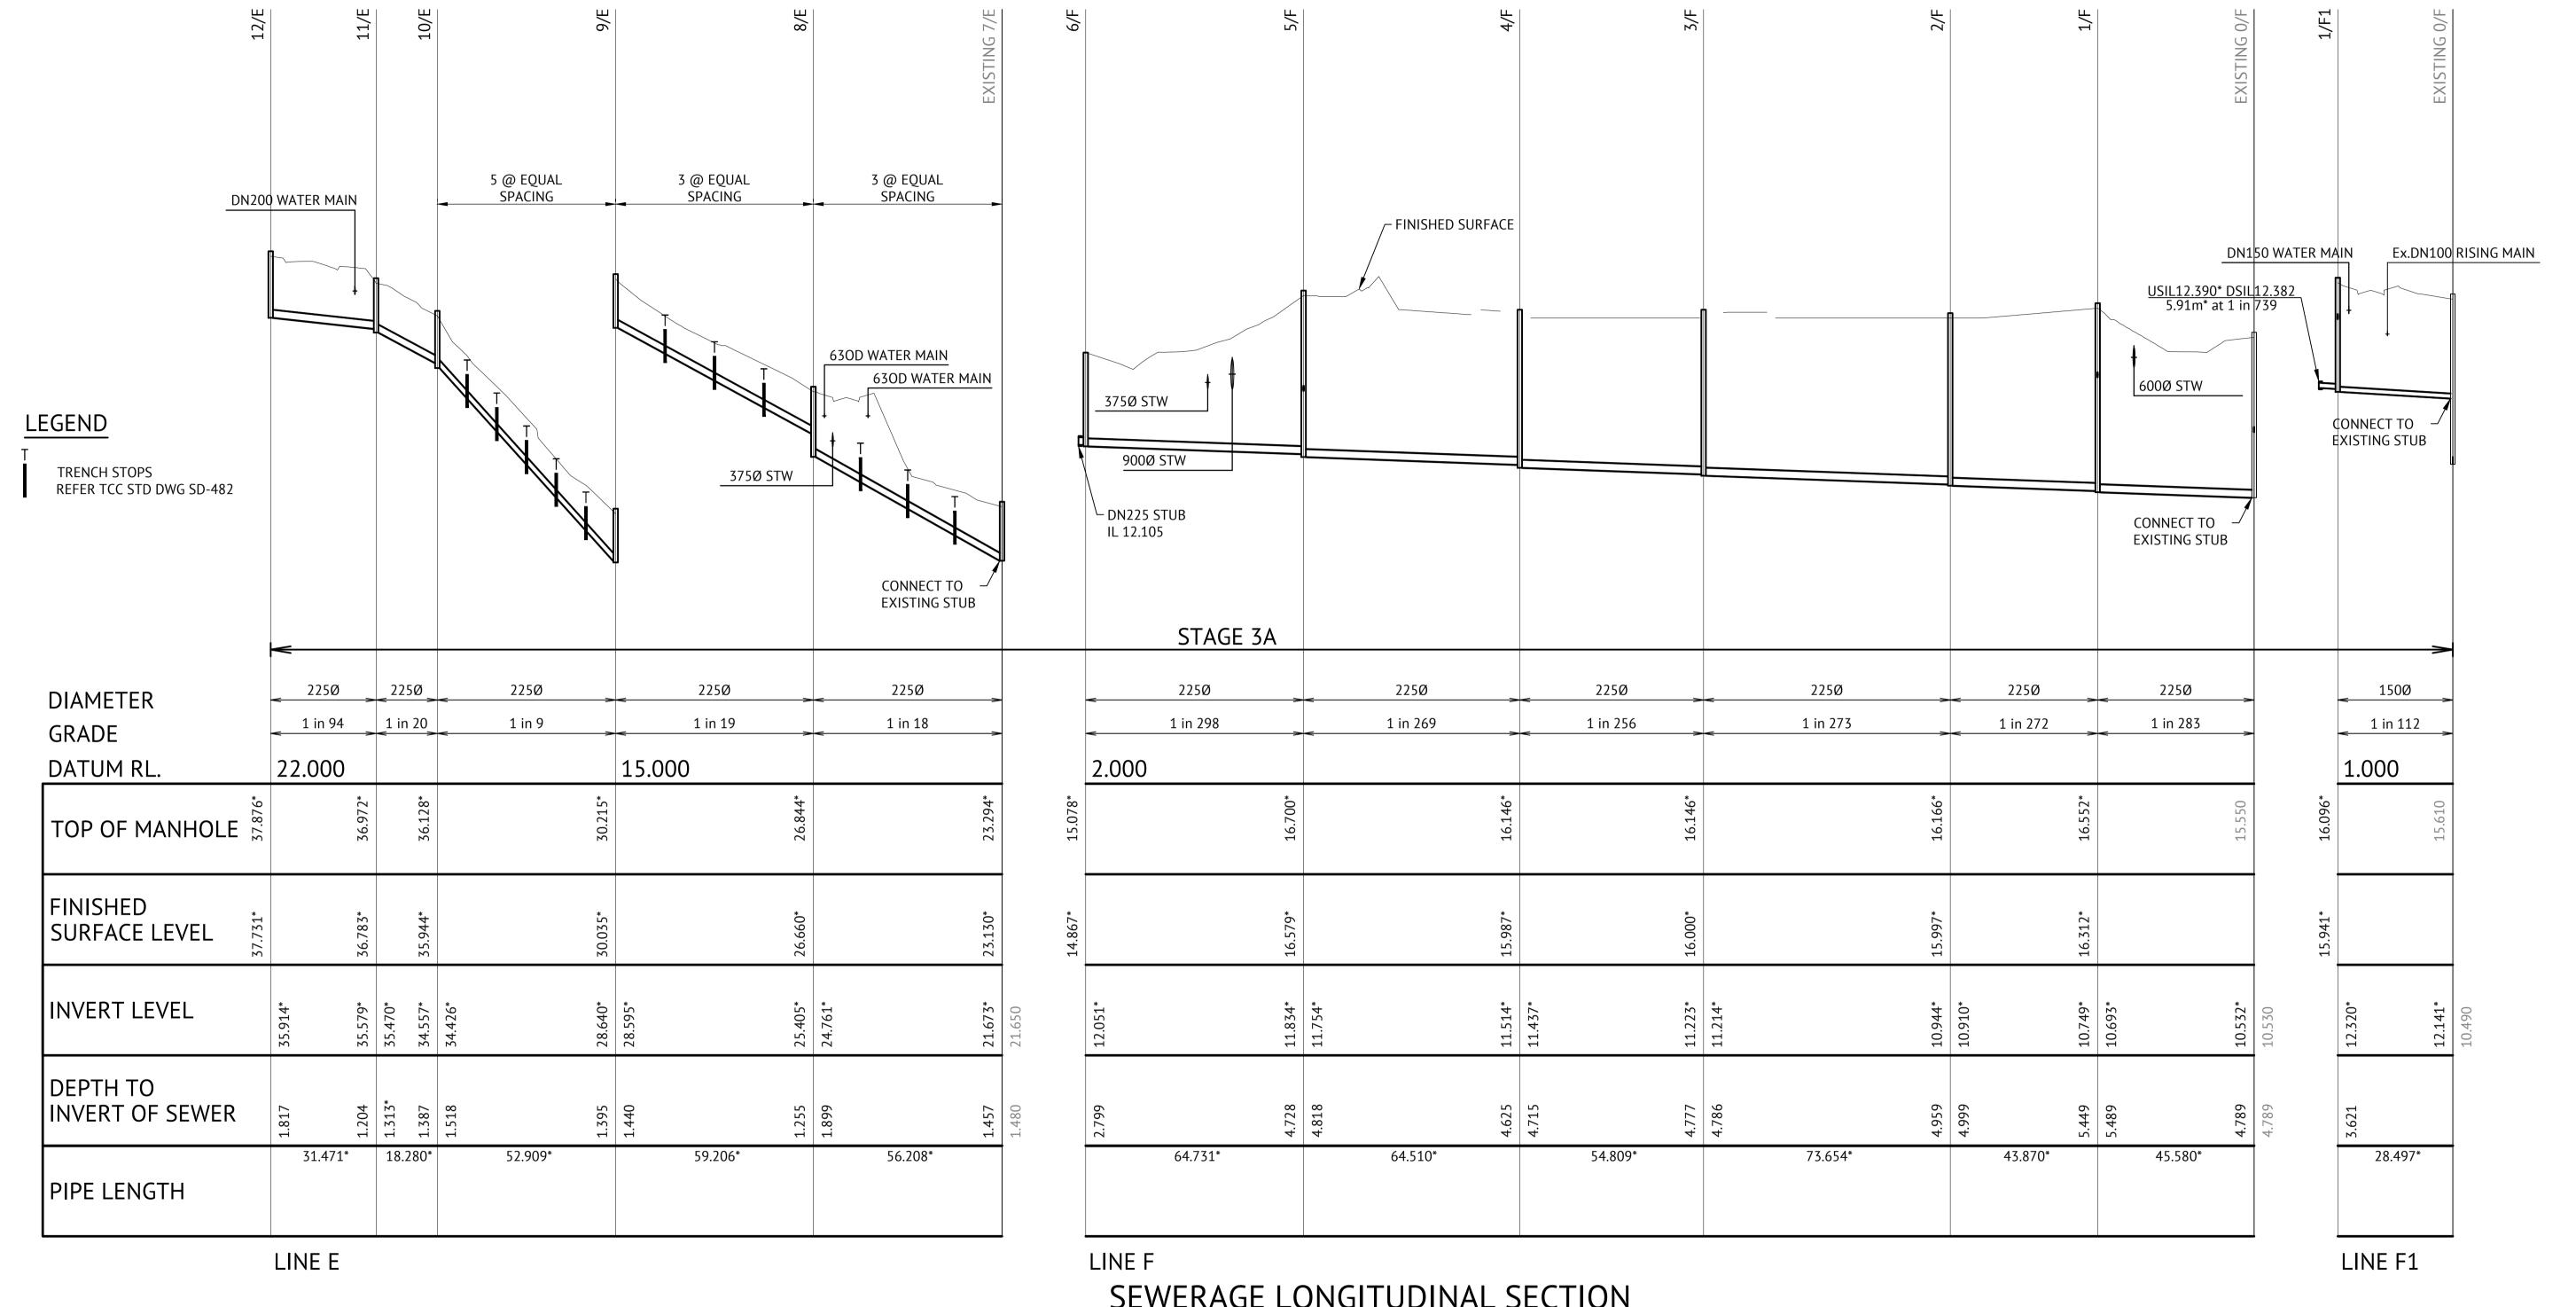

SEWERAGE LONGITUDINAL SECTION

SCALE 1:100 VERTICAL, SCALE 1:1000 HORIZONTAL

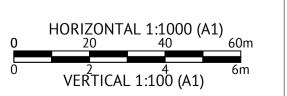

Revisio	Revisions			Level Datum: And (DERIVED)		
No.	Date	Details	Check	B.M. Used: PM200736		
Α	03.11.21	Original Issue	PAT	Coordinate Projection: Plane		
				Coordinate Datum: Arbitrary		
				Origin of Coordinates: PM200736	E:	62389.140
				Meridian:	N:	94092.020
				Map Reference:		
				Contour Interval:	Sur	veyed by: BM
				Job No: 27687-068-01	Dra	wn: MJM
				File No: 27687_149A.dwg	App	roved:

BRAZIER MOTTI PTY LTD (ACN 066 411 041), 595 Flinders Street, Townsville hereby certify that this Drawing accurately and correctly describes and records the nature and location of the works depicted by asterisks they have been constructed for subdivision.

MENDI CONSTRUCTIONS PTY LTD DO HEREBY CERTIFY THAT THE WORKS SHOWN ON THE 'AS CONSTRUCTED' DRAWINGS HAVE BEEN CONSTRUCTED IN ACCORDANCE WITH THE DRAWINGS AND CONTRACT DOCUMENTS APPROVED BY COUNCIL FOR THE CONSTRUCTION OF THE PROJECT.

AUTHORISED DELEGATE DATE .10/11/2021.....


PREMISE DO HEREBY CERTIFY THAT THE WORKS AS SHOWN ON THE 'AS CONSTRUCTED' DRAWINGS REFLECT ANY CHANGES THAT WERE MADE DURING THE COURSE OF CONSTRUCTION.

Det.	
RPEQ	
DATE10/11/21	

Client:	ELEMENTS	NQ PTY LTD
Project:	AS CONSTRUCTED -	- THE ORCHARD 3A
	DARLING RC	OAD, JENSEN
SE	EWER LONGITUDINAL S	SECTIONS - SHEET 1 OF 3
Local Authorit	y: Townsville City Council	Locality:




TOWNPLANNING

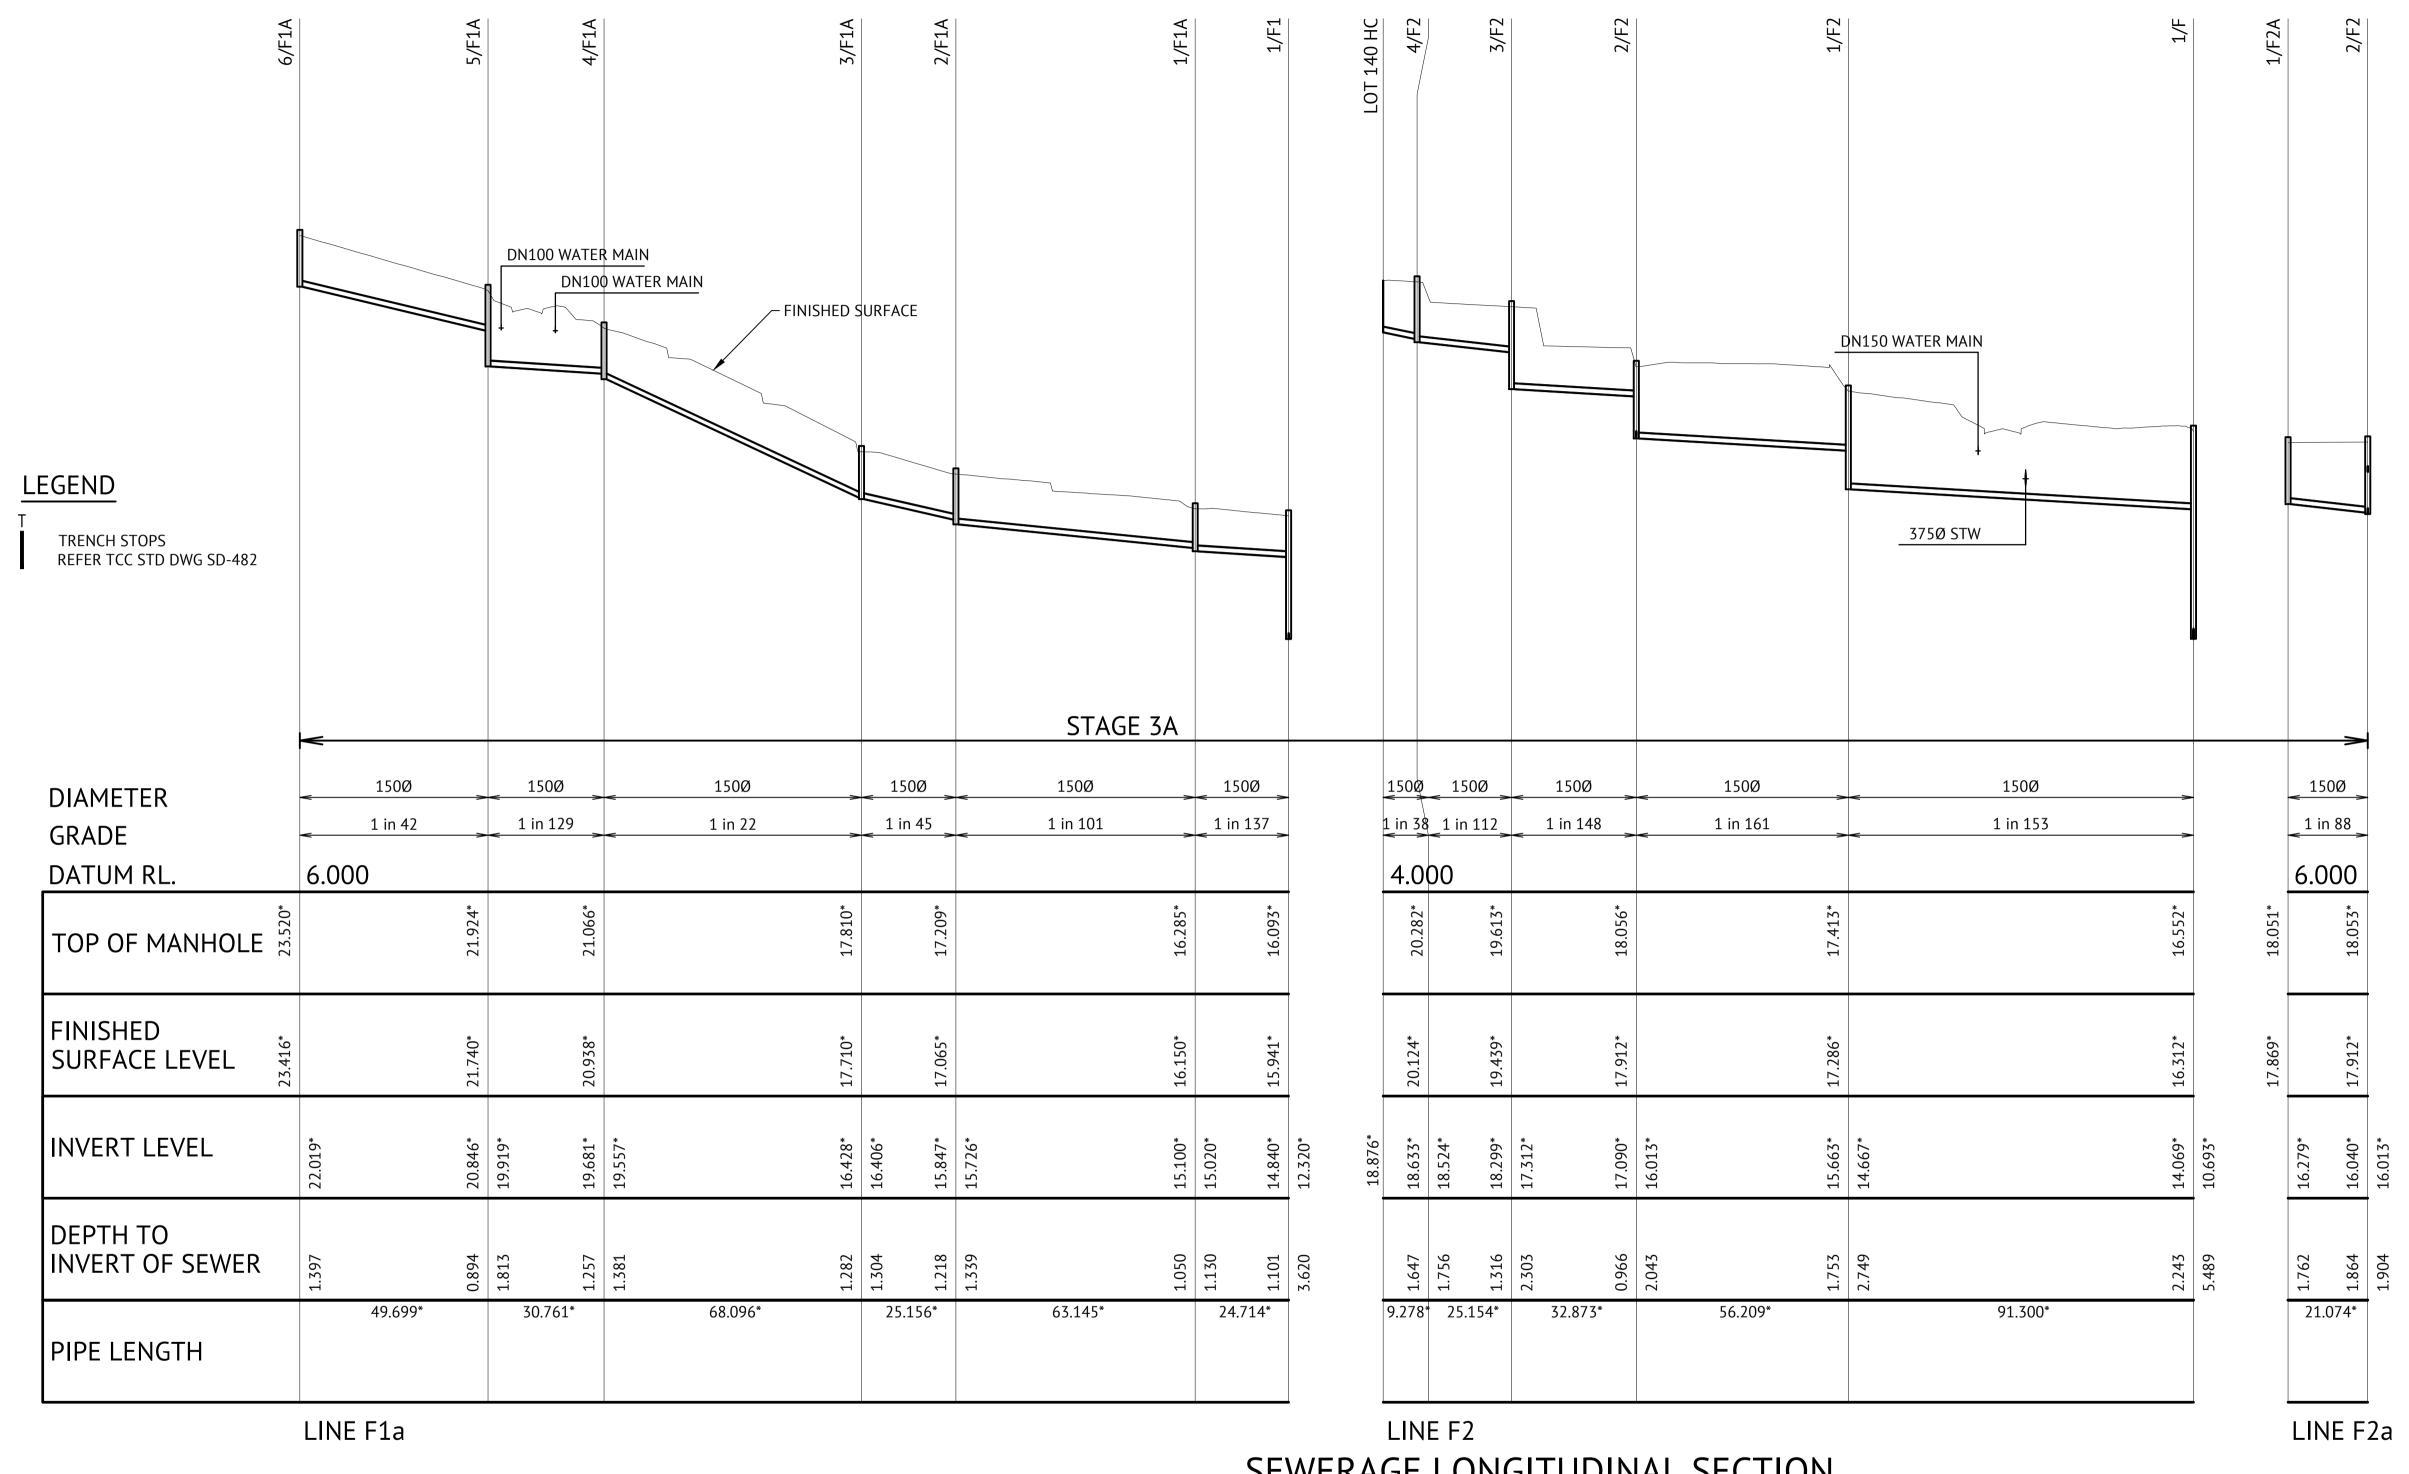

SEWERAGE LONGITUDINAL SECTION

SCALE 1:100 VERTICAL, SCALE 1:1000 HORIZONTAL

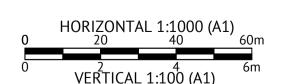

Level Datum: AHD (DERIVED) Check B.M. Used: PM200736 No. Date Details A 03.11.21 Original Issue PAT Coordinate Projection: Plane B 09.11.21 IL amended PAT Coordinate Datum: Arbitrary Origin of Coordinates: PM200736 E: 62389.140 N: 94092.020 Meridian: Map Reference: Contour Interval: Surveyed by: BM Job No: 27687-068-01 Drawn: MJM File No: 27687_150B.dwg Approved:

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RPEQ 13231 DATE ...10/11/21...


Client:	ELEMENTS NQ PTY LTD
Project:	
	AS CONSTRUCTED - THE ORCHARD 3A
	DARLING ROAD, JENSEN
	SEWER LONGITUDINAL SECTIONS - SHEET 2 OF 3

Locality:

Local Authority: Townsville City Council





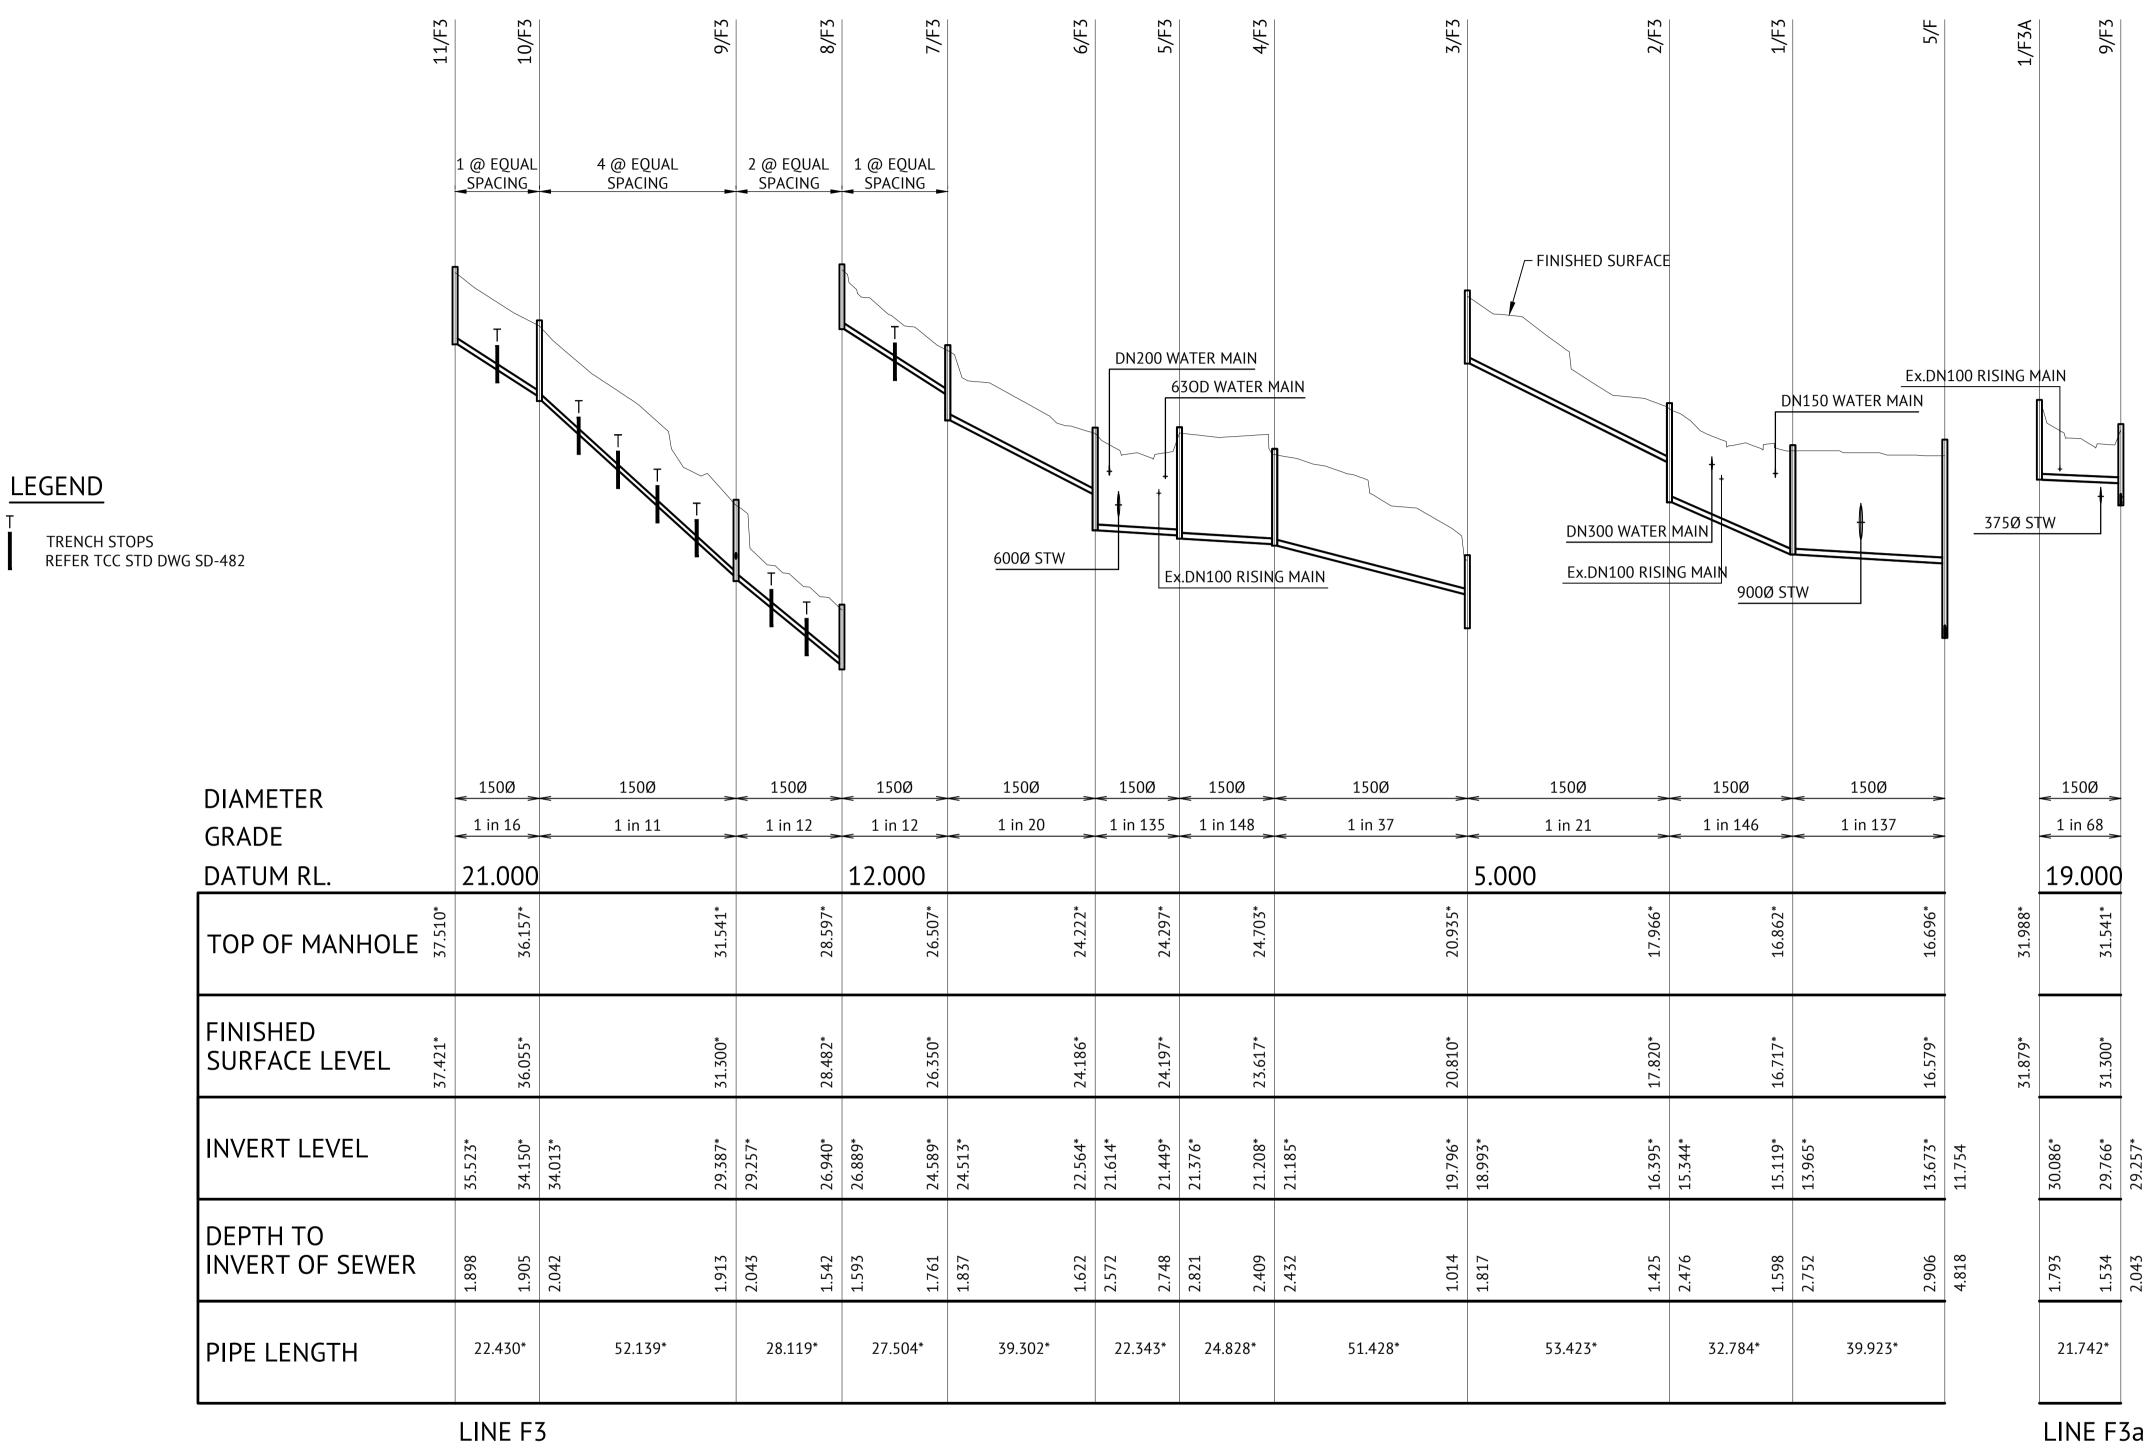

SEWERAGE LONGITUDINAL SECTION

SCALE 1:100 VERTICAL, SCALE 1:1000 HORIZONTAL



Revisions				Level Datum: AHD (DERIVED)		
No.	Date	Details	Check	B.M. Used: PM200736		
Α	03.11.21	Original Issue	PAT	Coordinate Projection: Plane		
				Coordinate Datum: Arbitrary		
				Origin of Coordinates: PM200736	E:	62389.140
				Meridian:	N:	94092.020
				Map Reference:		
				Contour Interval:	Surveyed by: BM	
				Job No: 27687-068-01	Drawn: MJM	
				File No: 27687_151A.dwg	Approved:	

BRAZIER MOTTI PTY LTD (ACN 066 411 041), 595 Flinders Street, Townsville hereby certify that this Drawing accurately and correctly describes and records the nature and location of the works depicted by asterisks (** Aereon as they have been constructed for subdivision.

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AUTHORISED DELEGATEDATE ..10/11/2021......

PREMISE DO HEREBY CERTIFY THAT THE WORKS AS SHOWN ON THE 'AS CONSTRUCTED' DRAWINGS REFLECT ANY CHANGES THAT WERE MADE DURING THE COURSE OF CONSTRUCTION.

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RPEO	13231
DATE	10/11/21

Client:						
	ELEMENTS NQ PTY LTD					
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Project:						
	AS CONSTRUCTED - THE ORCHARD 3A					
	AS CONSTRUCTED THE ORCHARD SA					
	DARLING ROAD, JENSEN					
	DANLING NOAD, JENSEN					
	SEWER LONGITUDINAL SECTIONS - SHEET 3 OF 3					
-	SEWER LUNGITUDINAL SECTIONS - SHEET S OF S					


Locality:

Local Authority: Townsville City Council







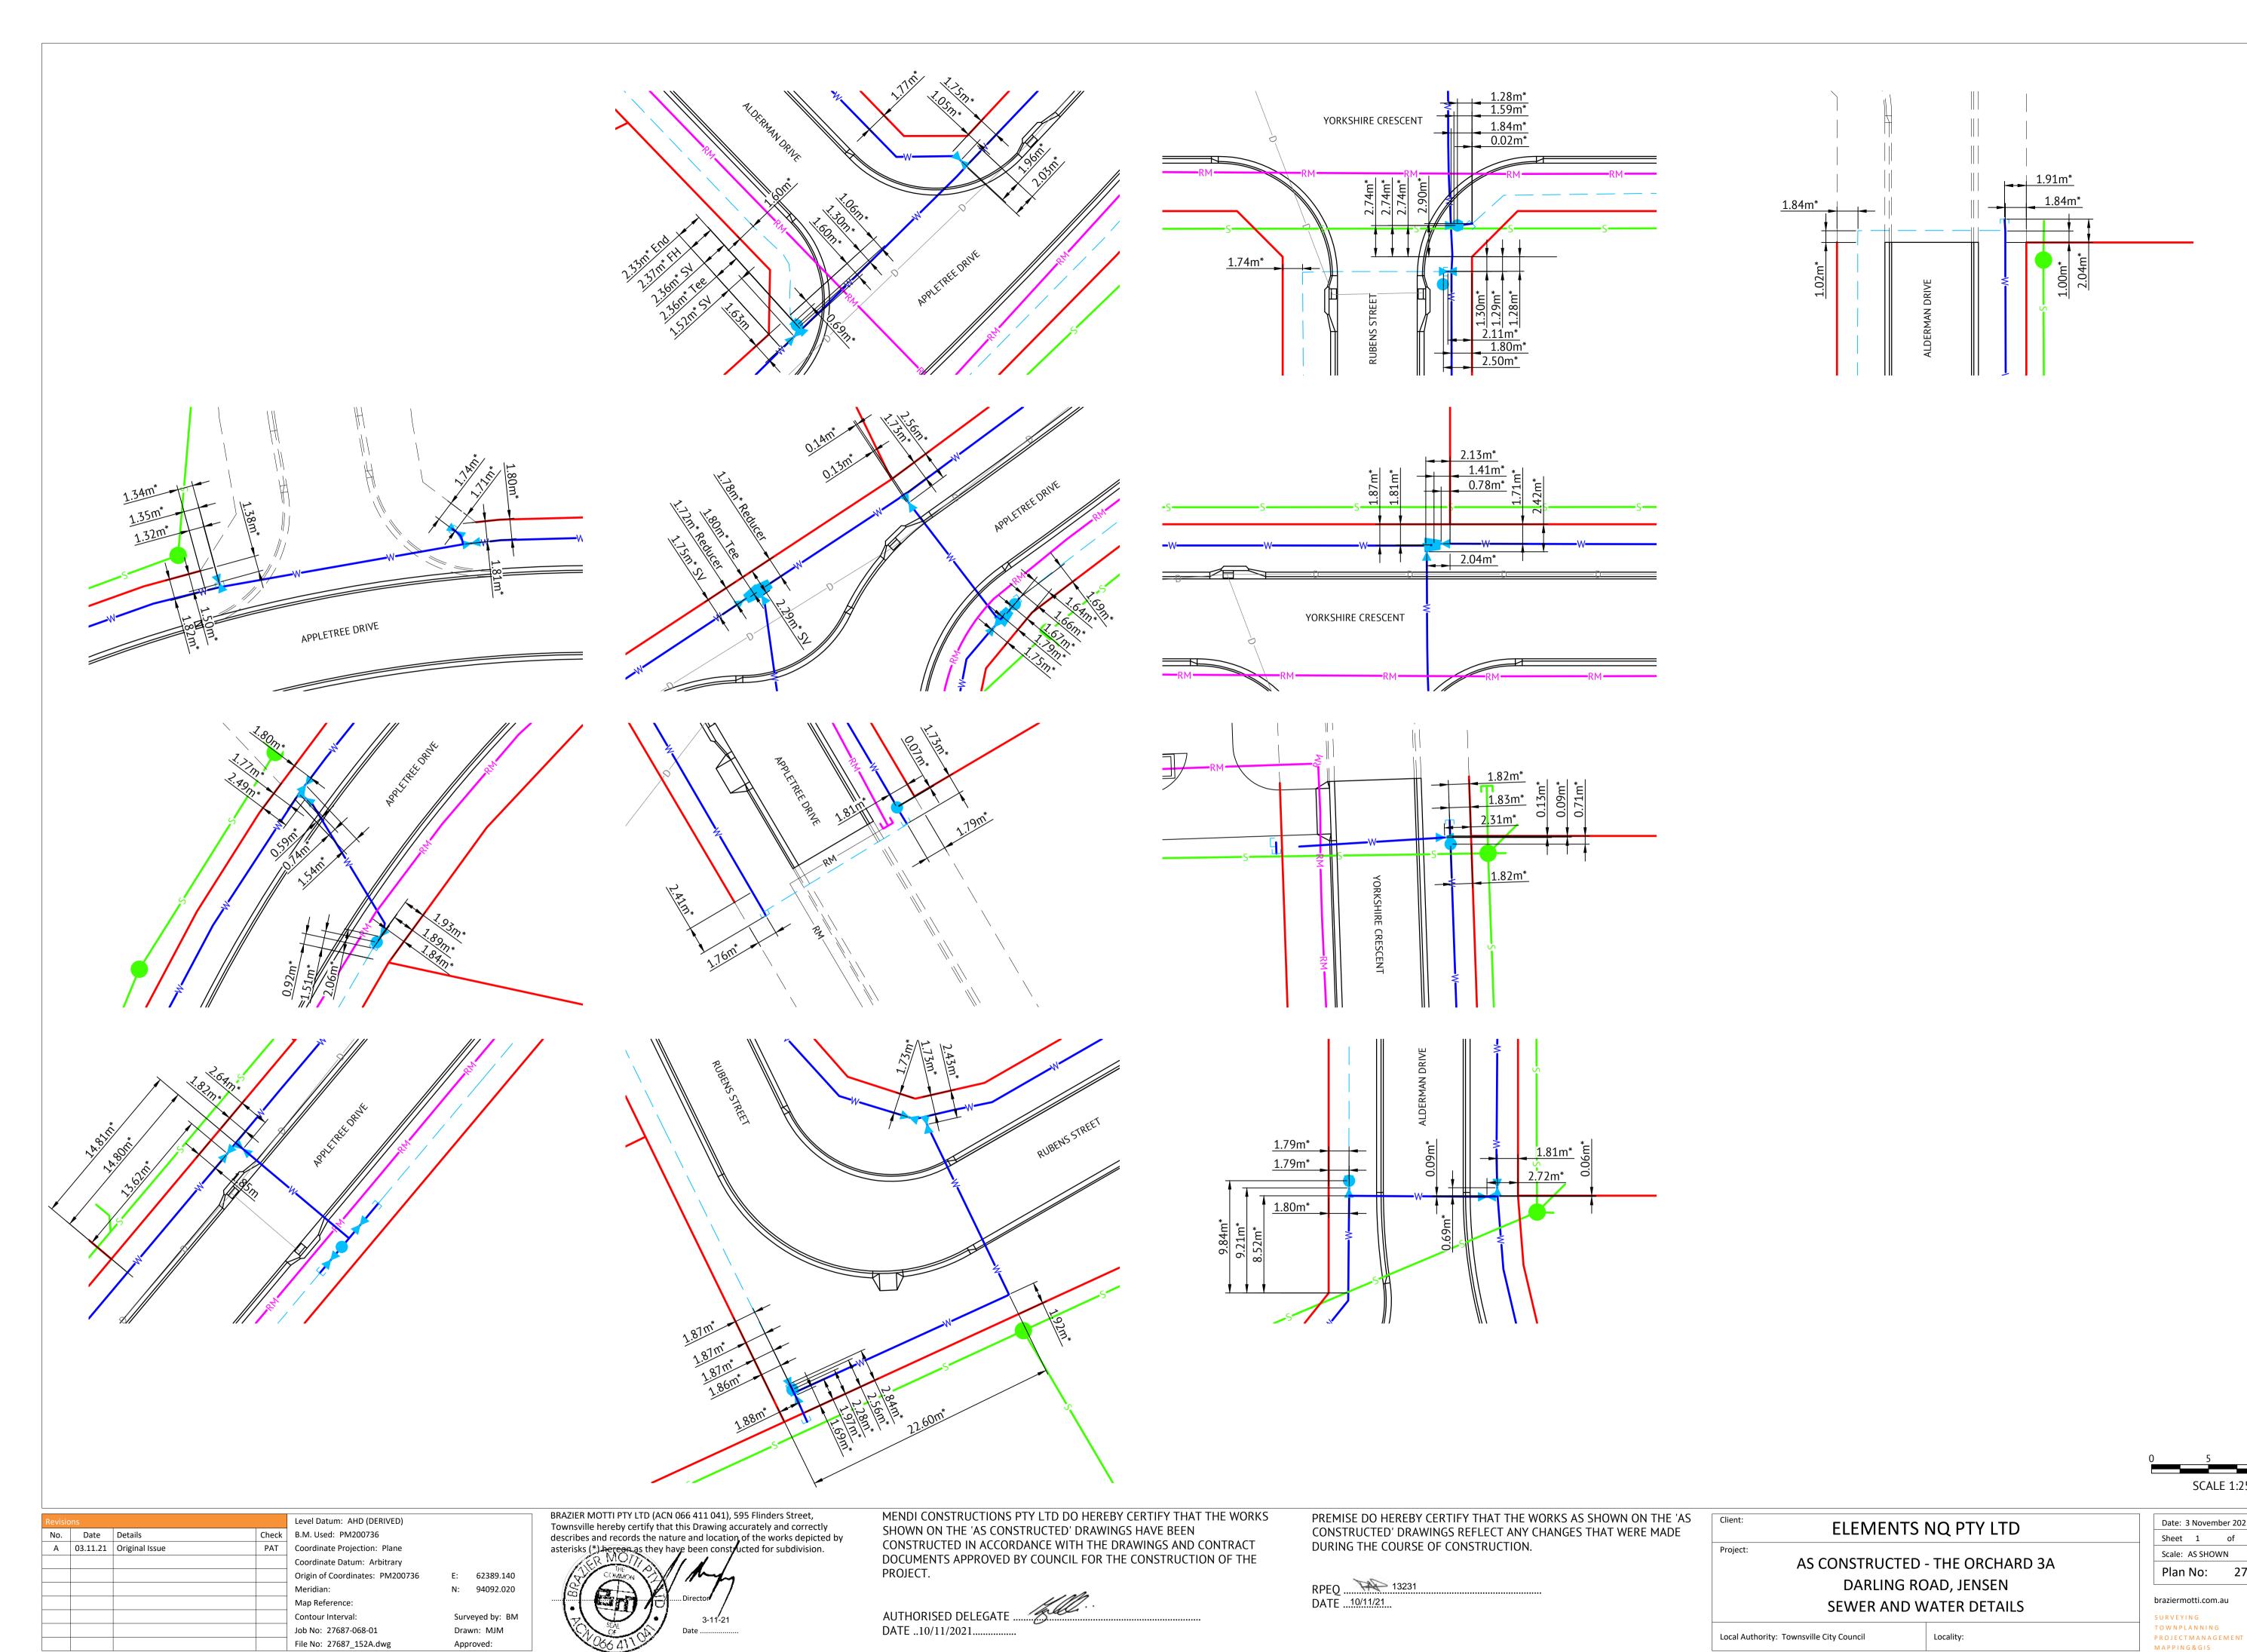

SCALE 1:250 (A1) Scale: AS SHOWN Plan No: 27687/152 A