


THE ORCHARD STAGE 3 DARLING ROAD, JENSEN FOR ELEMENTS NQ PTY LTD

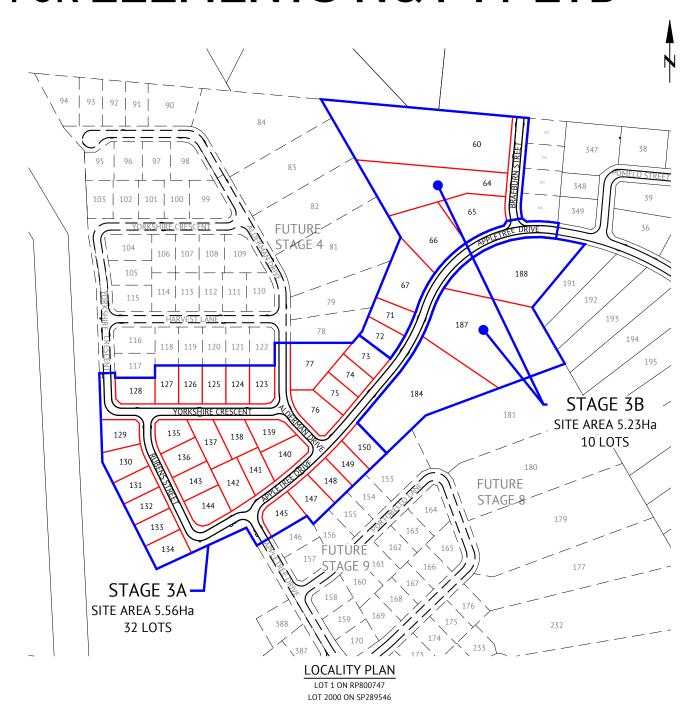

SURVEY BY BRAZIER MOTTI					
VERTICAL ALIGNMENT BASED ON					
PSM 130676	RL = 19.506				
PSM 106258	RL = 17.525				
PSM 121574	RL = 16902				
PSM 131697	RL = 16.732				
HORIZONTAL ALIGNI	MENT BASED ON THE				
FOLLOWING PSM AND THEIR COORDINATES					
PSM 131697					
PSM 5	56629				
PSM S	98041				
PSM 130676					
PSM 121640					
PSM 1	06258				

PRELIMINARY - NOT FOR CONSTRUCTION								
16/12/20	3	LOT LAYOUT REVISED	GB	PP				
28/08/20	2	FOR OPERATIONAL WORKS APPROVAL	GB	PP				
17/07/20	1	FOR BULK EARTHWORKS APPROVAL	GB	PP				
DATE	DATE REV DESCRIPTION REC							
		REVISIONS						





CLIENT	ELEMENTS NQ PTY LTD	JOB CODE
PROJECT	THE ORCHARD - STAGE 3	l ELE-
LOCATION	DARLING ROAD, JENSEN	SHEET NUMBER
SHEET TITLE	COVER SHEET, LOCALITY PLAN & DRAWING SCHEDULE	C00

SHEET LIST TABLE

COVER SHEET, LOCALITY PLAN & DRAWING SCHEDULE

ROADWORKS & STORMWATER DRAINAGE PLAN - SHEET 1 OF 3

ROADWORKS & STORMWATER DRAINAGE PLAN - SHEET 2 OF 3
ROADWORKS & STORMWATER DRAINAGE PLAN - SHEET 3 OF 3
APPLETREE DRIVE LONGITUDINAL SECTION - SHEET 1 OF 2

APPLETREE DRIVE LONGITUDINAL SECTION - SHEET 2 OF 2

APPLETREE DRIVE CROSS SECTIONS - SHEET 1 OF 2

APPLETREE DRIVE CROSS SECTIONS - SHEET 2 OF 2

BRAEBURN STREET LONGITUDINAL & CROSS SECTIONS

ALDERMAN DRIVE LONGITUDINAL & CROSS SECTIONS
RUBENS STREET LONGITUDINAL SECTION
RUBENS STREET CROSS SECTIONS

Q2 STORMWATER LONGITUDINAL SECTION - SHEET 1 OF 2

Q2 STORMWATER LONGITUDINAL SECTION - SHEET 2 OF 2

WATER & SEWERAGE RETICULATION PLAN - SHEET 1 OF 3

WATER & SEWERAGE RETICULATION PLAN - SHEET 2 OF 3

WATER & SEWERAGE RETICULATION PLAN - SHEET 3 OF 3

SOIL EROSION & SEDIMENT CONTROL - CONSTRUCTION PHASE

SOIL EROSION & SEDIMENT CONTROL - DETAILS PLAN

Q100 STORMWATER CATCHMENT PLAN & DATA TABLES

SOIL FROSION & SEDIMENT CONTROL - POST CONSTRUCTION PHASE

-0006

SEWER LONGITUDINAL SECTIONS - SHEET 1 OF 3

SEWER LONGITUDINAL SECTIONS - SHEET 2 OF 3
SEWER LONGITUDINAL SECTIONS - SHEET 3 OF 3

Q2 STORMWATER CATCHMENT PLAN Q2 STORMWATER DATA TABLE

YORKSHIRE CRESCENT LONGITUDINAL SECTION

YORKSHIRE CRESCENT CROSS SECTIONS
ROADWORKS DETAILS PLAN

EARTHWORKS LAYOUT PLAN - SHEET 1 OF 3
EARTHWORKS LAYOUT PLAN - SHEET 2 OF 3
FARTHWORKS LAYOUT PLAN - SHEET 3 OF 3

SAFETY IN DESIGN REPORT ROAD GEOMETRY PLAN

SHEET TITLE

SHEET NO.

C002

C011

C015


C019


C024


C028

C032

DELETED

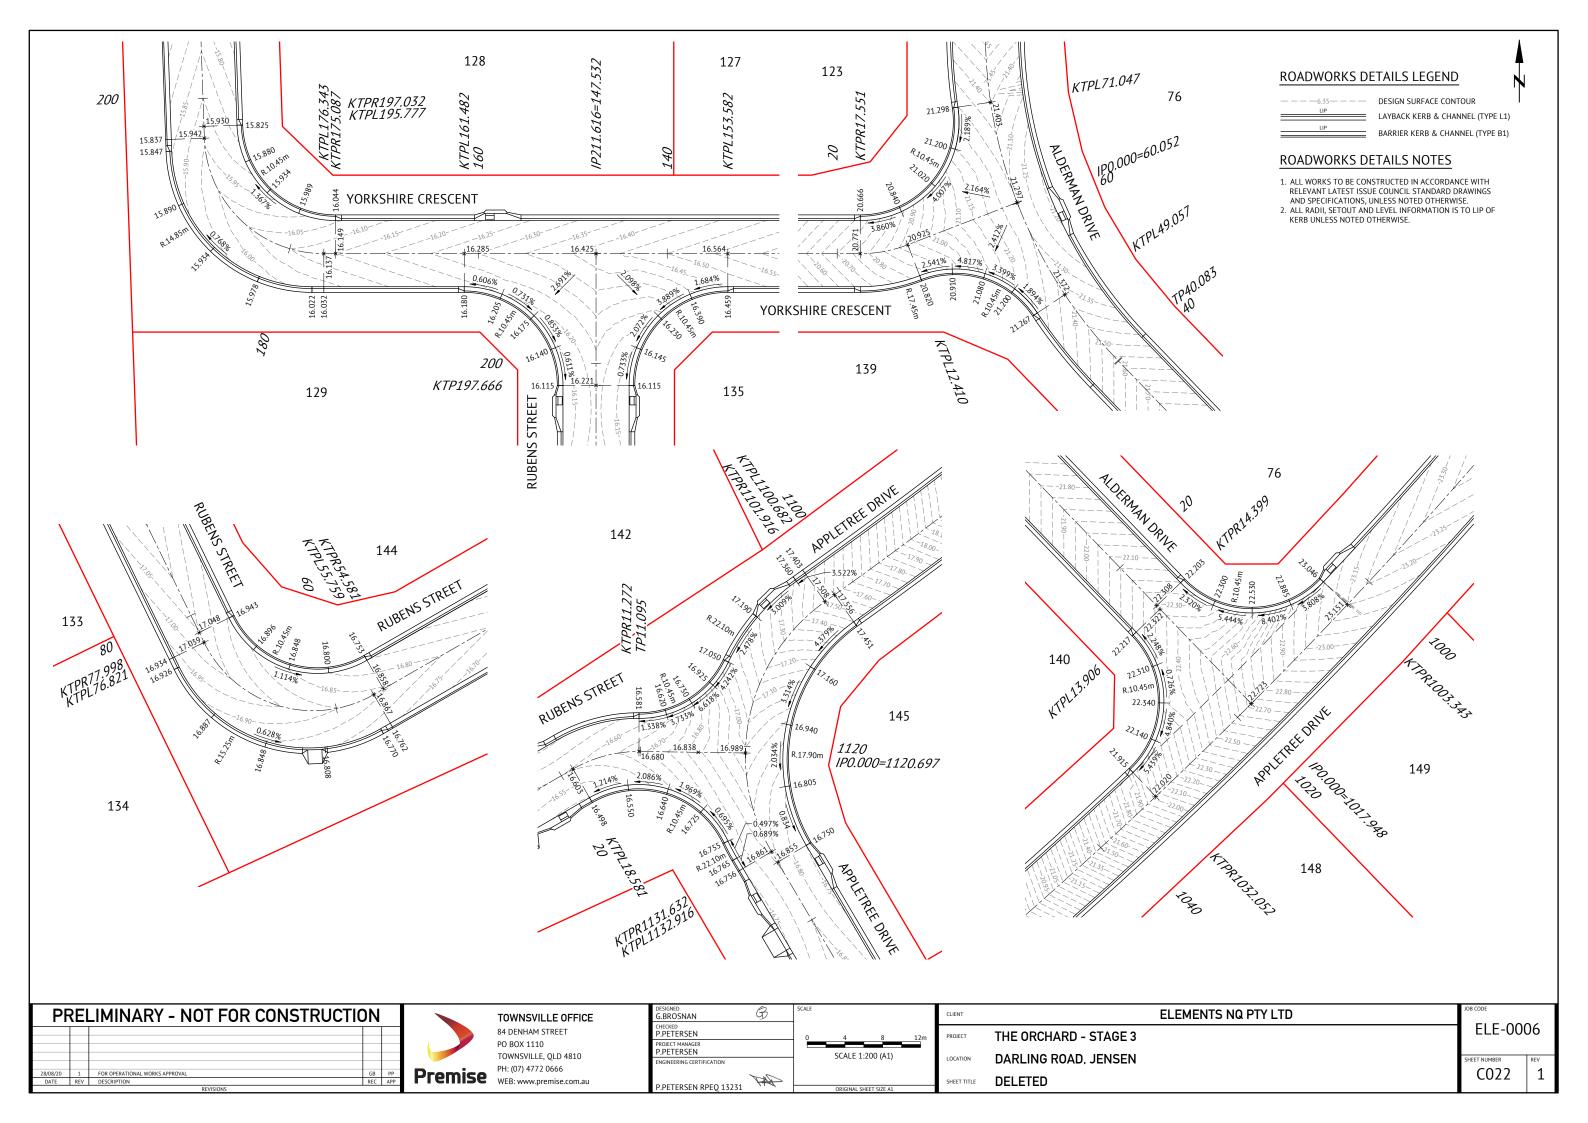

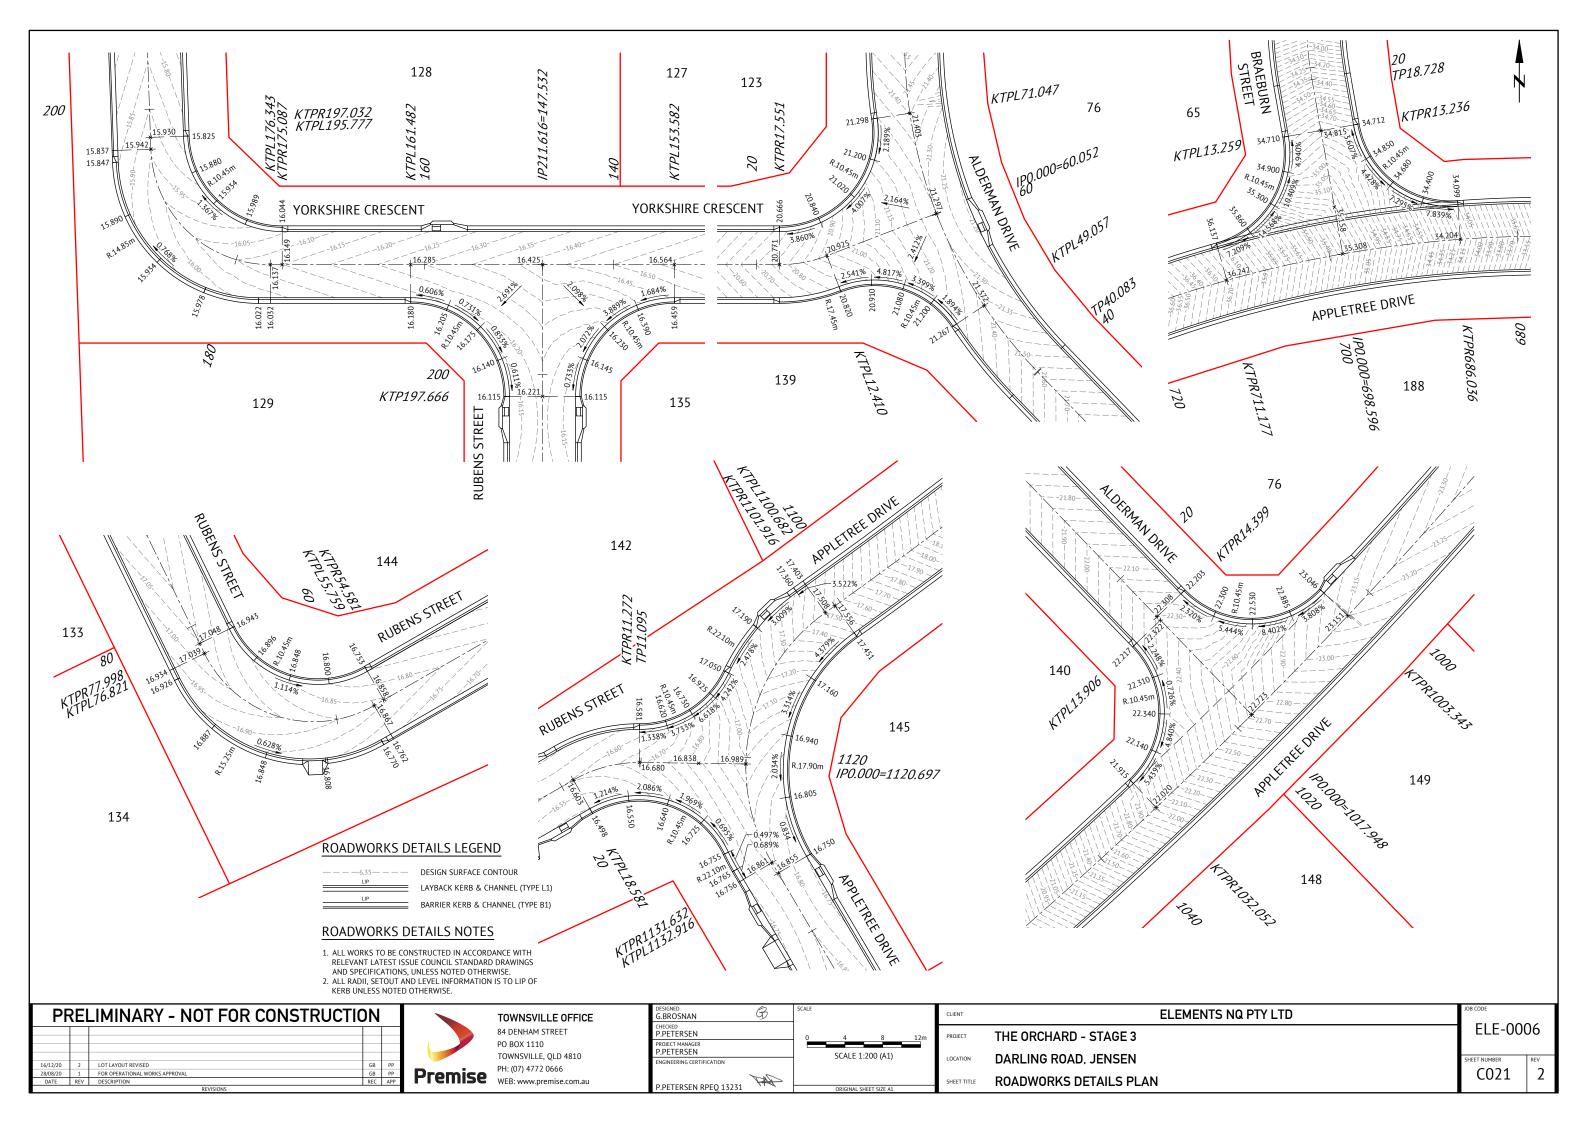

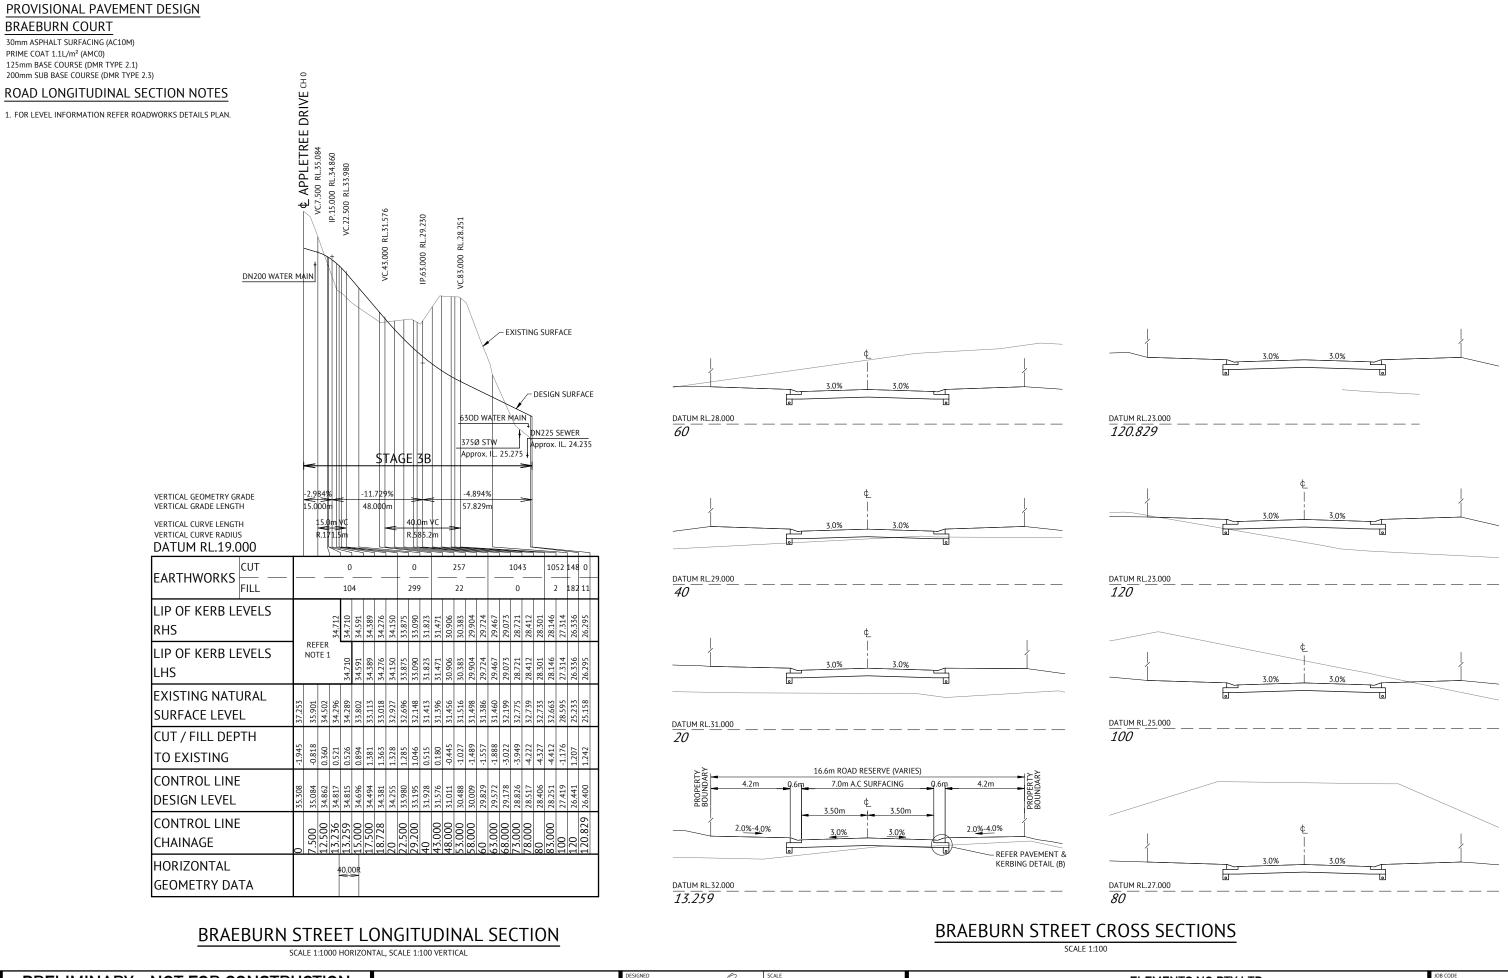


PF	PRELIMINARY - NOT FOR CONSTRUCTION				
16/12/20	2	LOT LAYOUT REVISED	GB	PP	
28/08/20	1	FOR OPERATIONAL WORKS APPROVAL	GB	PP	
DATE	REV	DESCRIPTION	REC	APP	





TOWNSVILLE OFFICE 84 DENHAM STREET PO BOX 1110 TOWNSVILLE, QLD 4810 PH: (07) 4772 0666

P PETERSEN 0 3 4	50m	I
P PETERSEN 0 3 4	30111	
CENTER 4007/44)	6m	ľ
PROJECT MANAGER P.PETERSEN SCALE 1:100 (A1)		
ENGINEERING CERTIFICATION		ı
P.PETERSEN RPEO 13231 ORIGINAL SHFFT SIZE A1		ı
P.PETERSEN RPEQ 13231 ORIGINAL SHEET SIZE A1		L

CLIENT	ELEMENTS NQ PTY LTD	JOB CODE	
PROJECT	THE ORCHARD - STAGE 3	ELE-000)6
LOCATION	DARLING ROAD, JENSEN	SHEET NUMBER	REV
SHEET TITLE	BRAEBURN STREET LONGITUDINAL & CROSS SECTIONS	C014	2

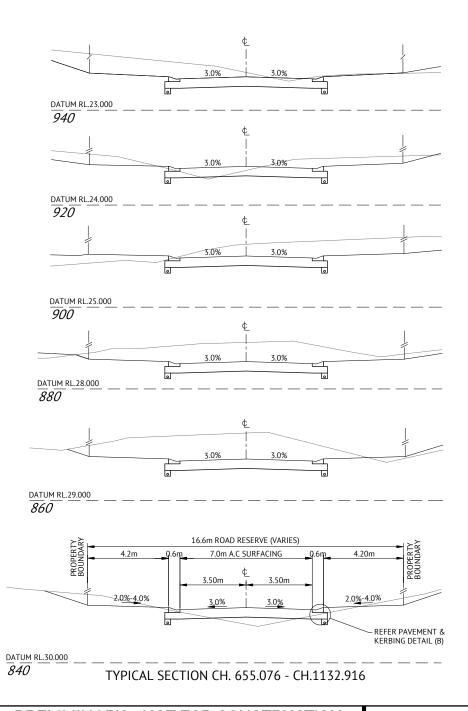

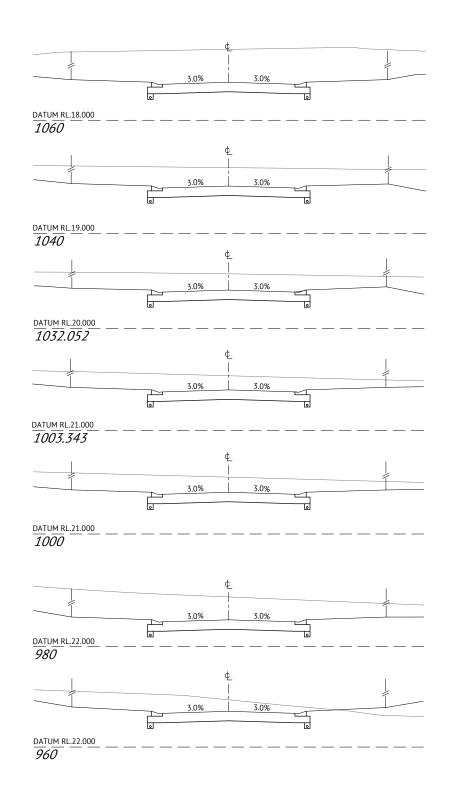

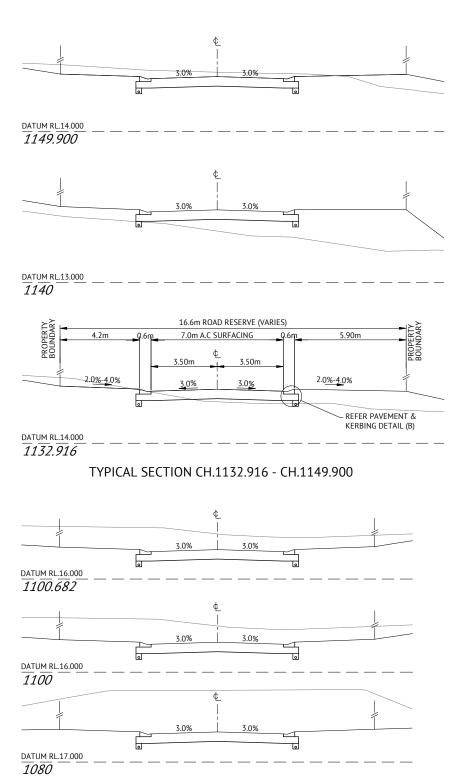


APPLETREE DRIVE CROSS SECTIONS SCALE 1:100


PRELIMINARY - NOT FOR CONSTRUCTION





TOWNSVILLE OFFICE 84 DENHAM STREET PO BOX 1110 TOWNSVILLE, QLD 4810 Premise PH: (07) 4772 0666
WEB: www.premise.com.au

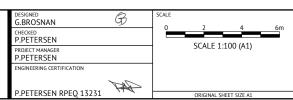



CLIENT	ELEMENTS NQ PTY LTD	JOB CODE	
PROJECT	THE ORCHARD - STAGE 3	ELE-000	J6
LOCATION	DARLING ROAD, JENSEN	SHEET NUMBER	REV
SHEET TITLE	APPLETREE DRIVE CROSS SECTIONS - SHEET 2 OF 2	C013	2

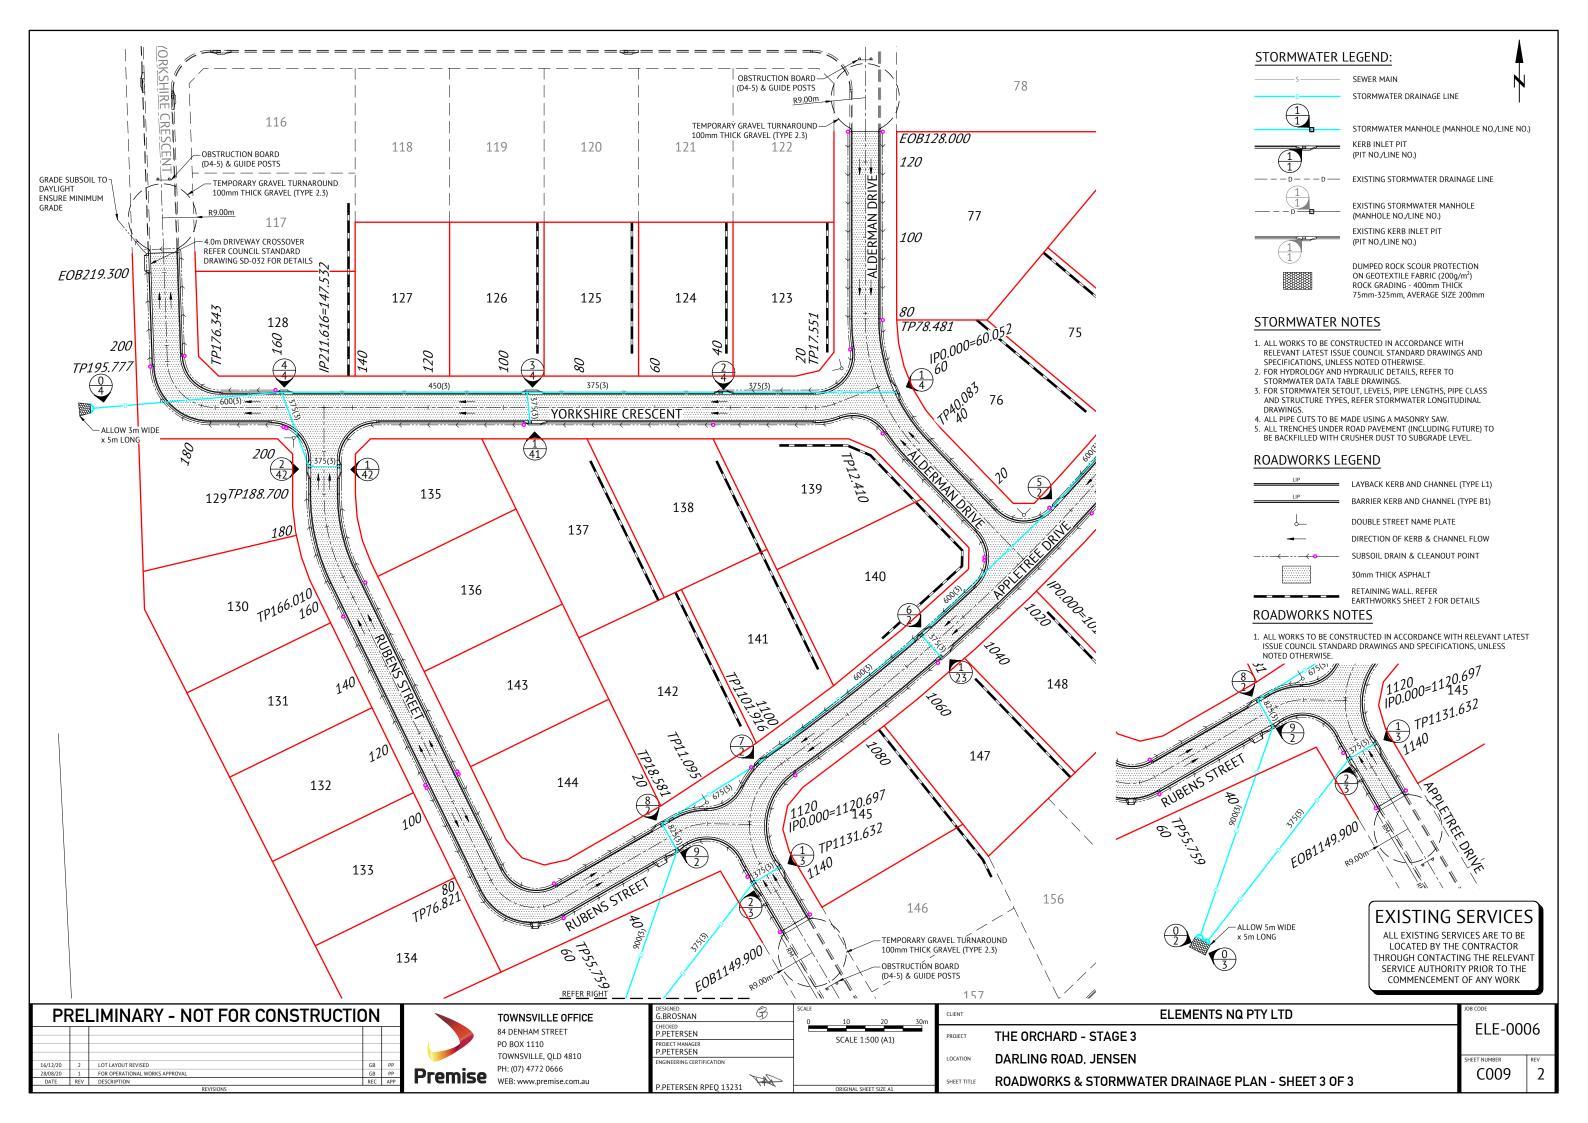


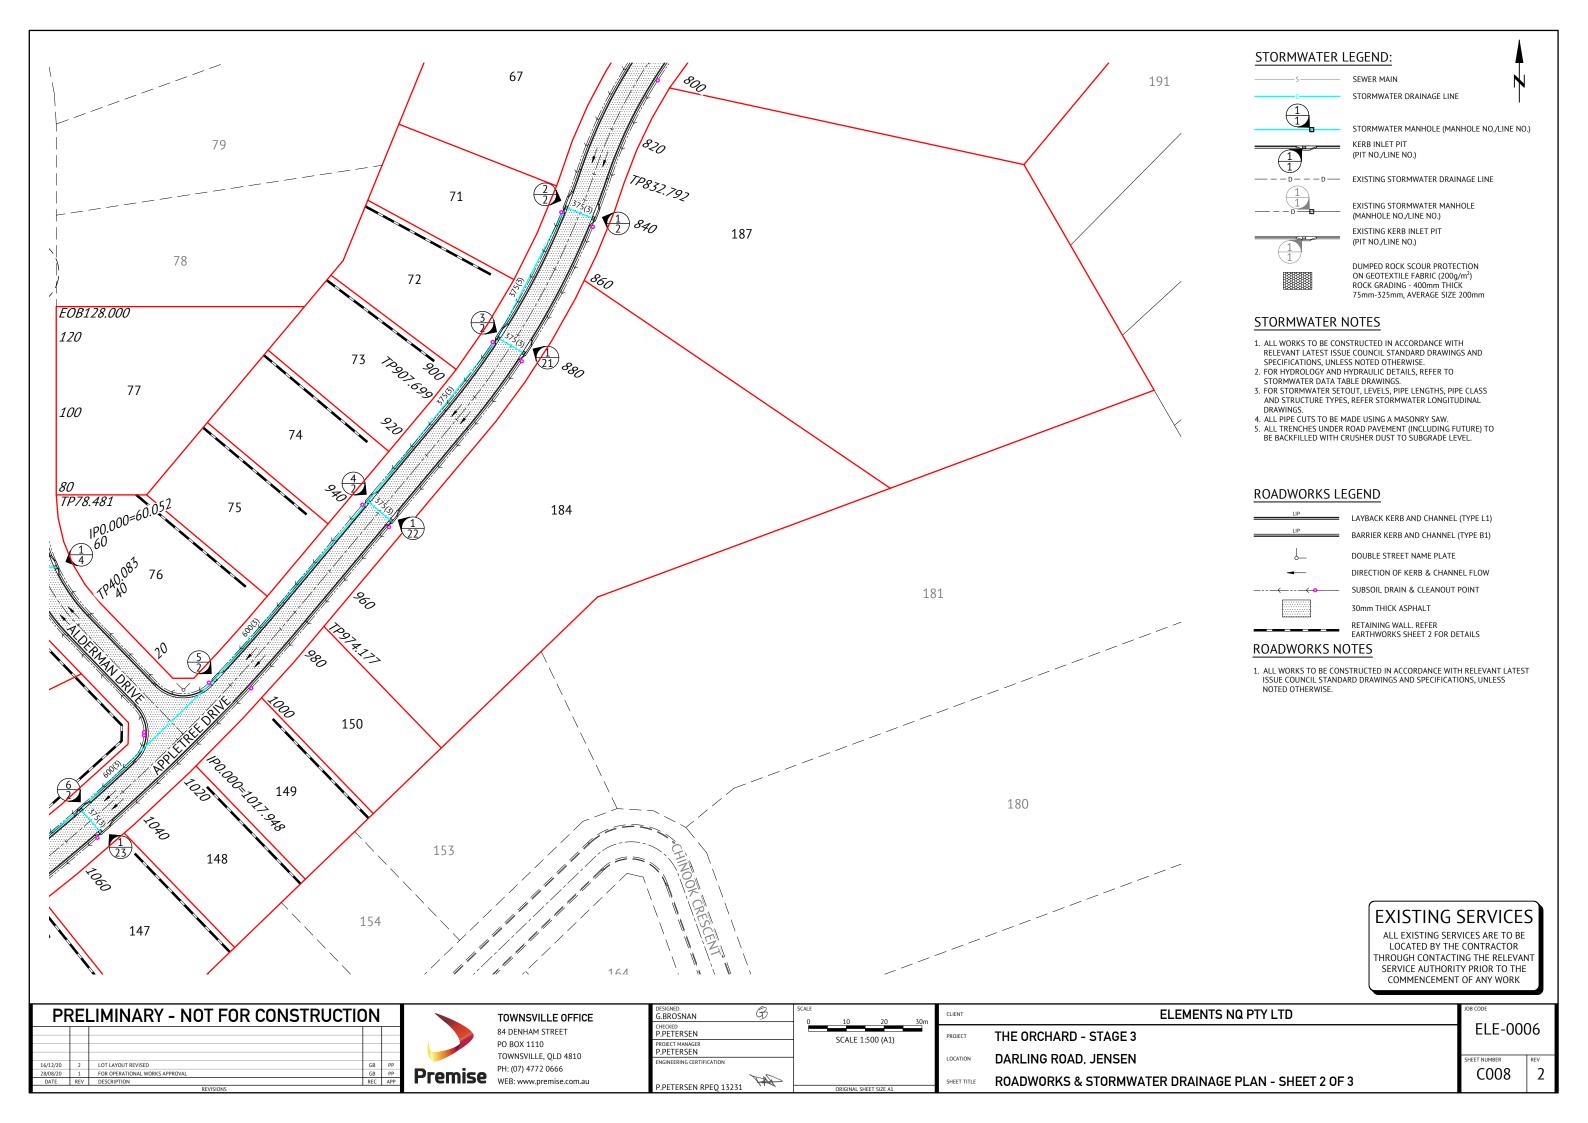


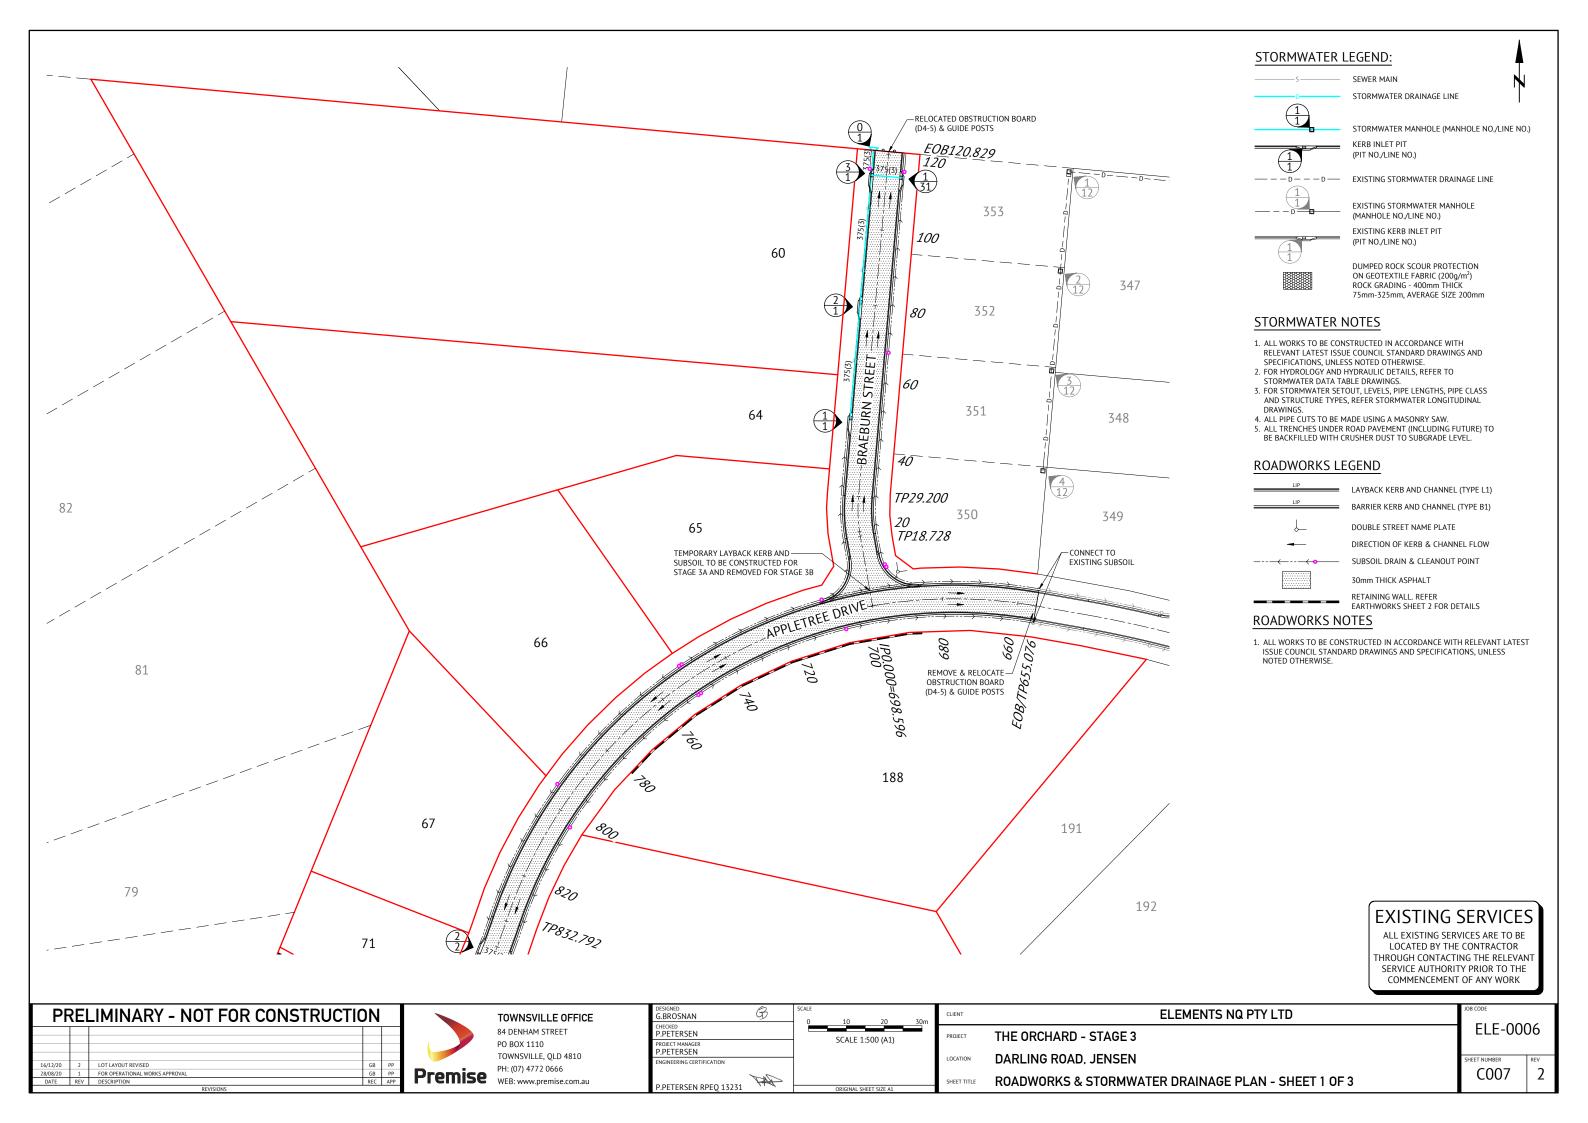

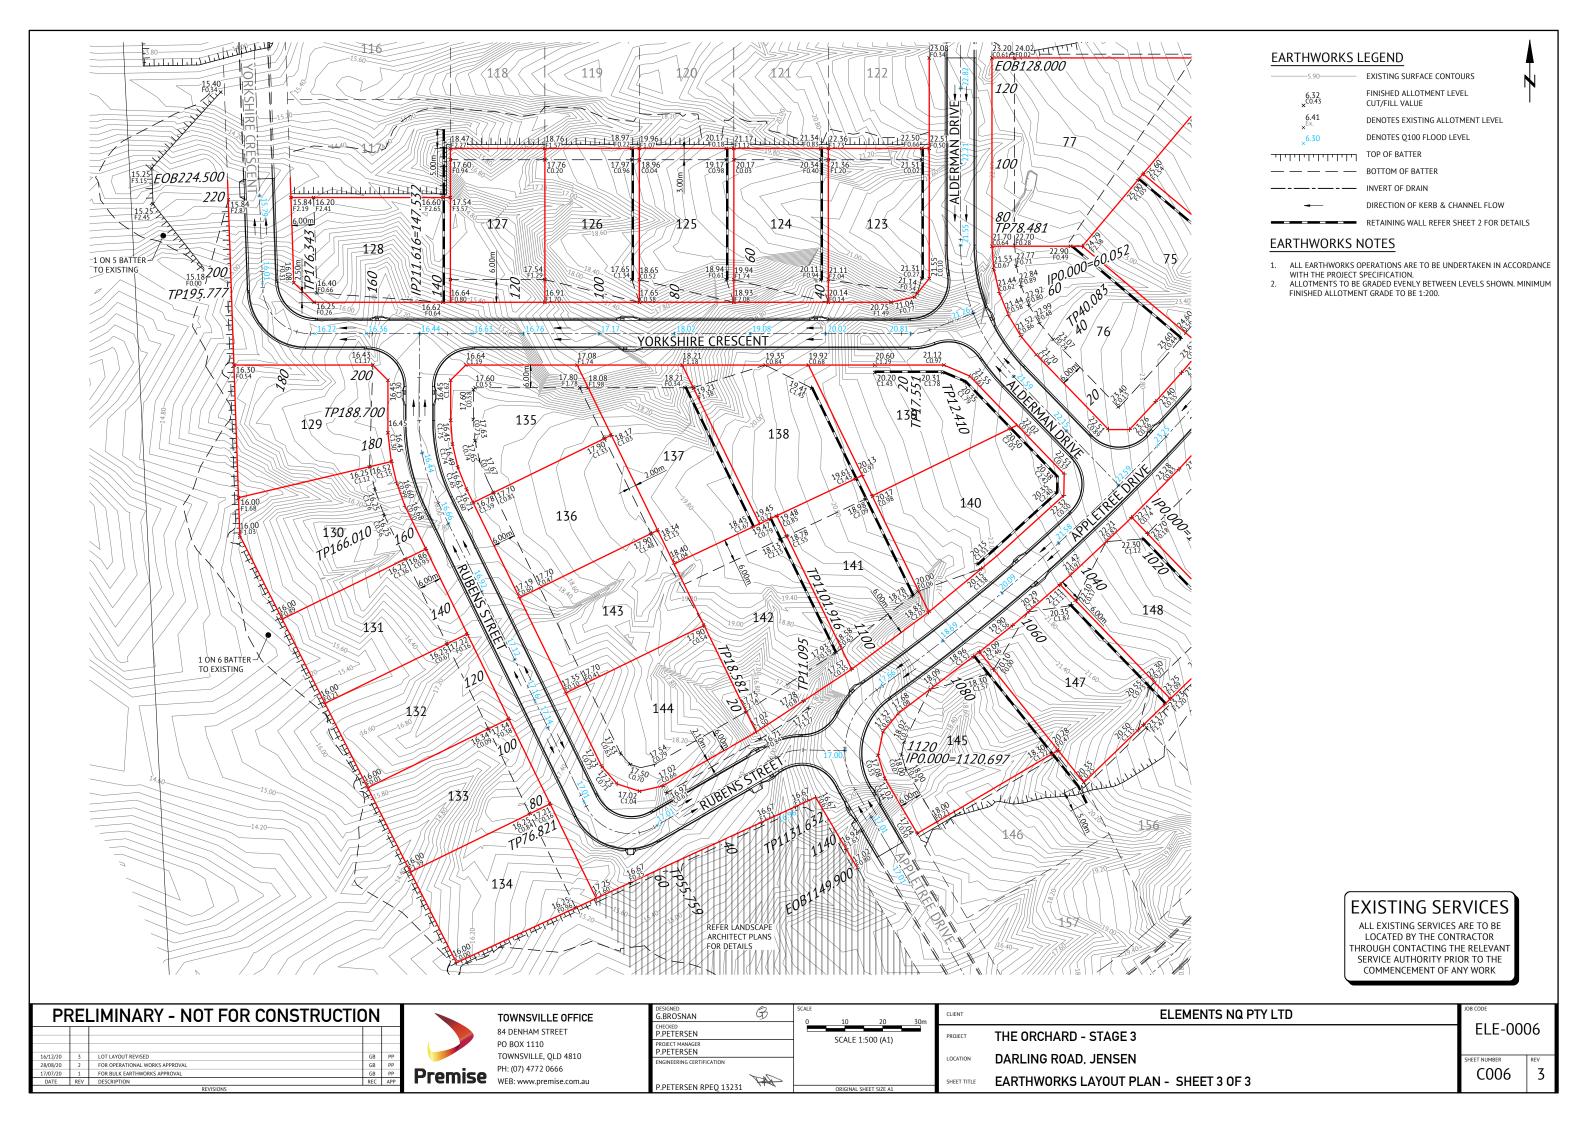

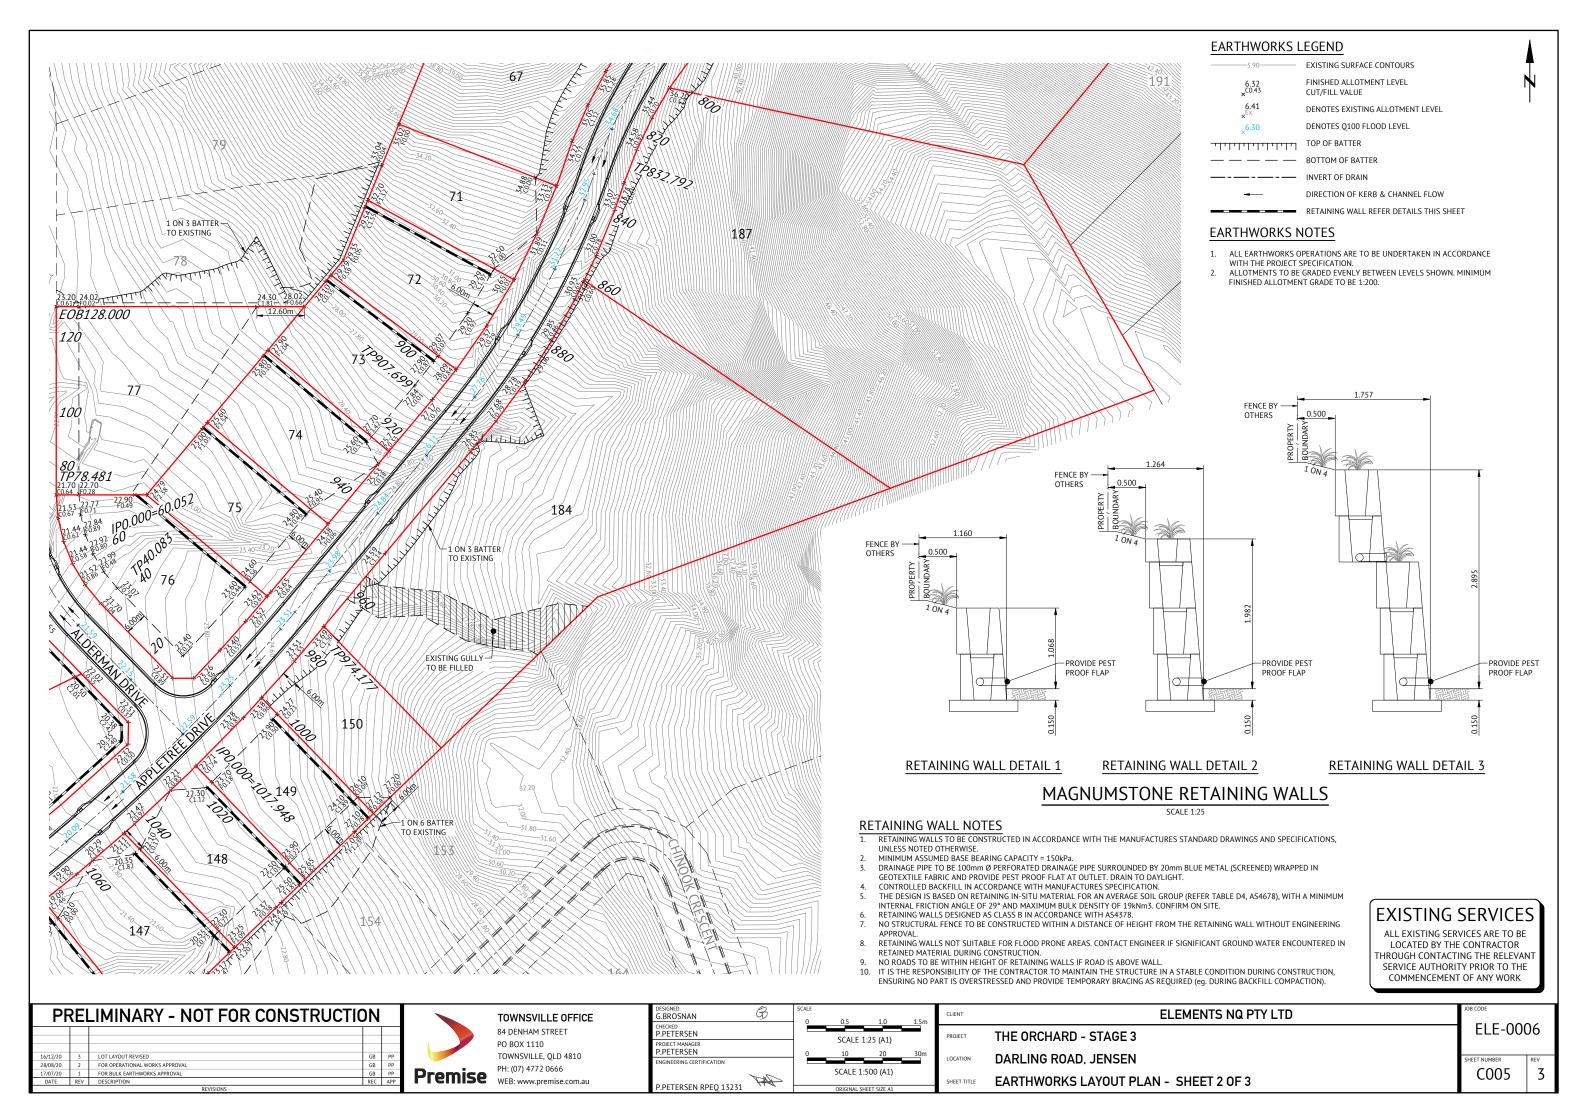

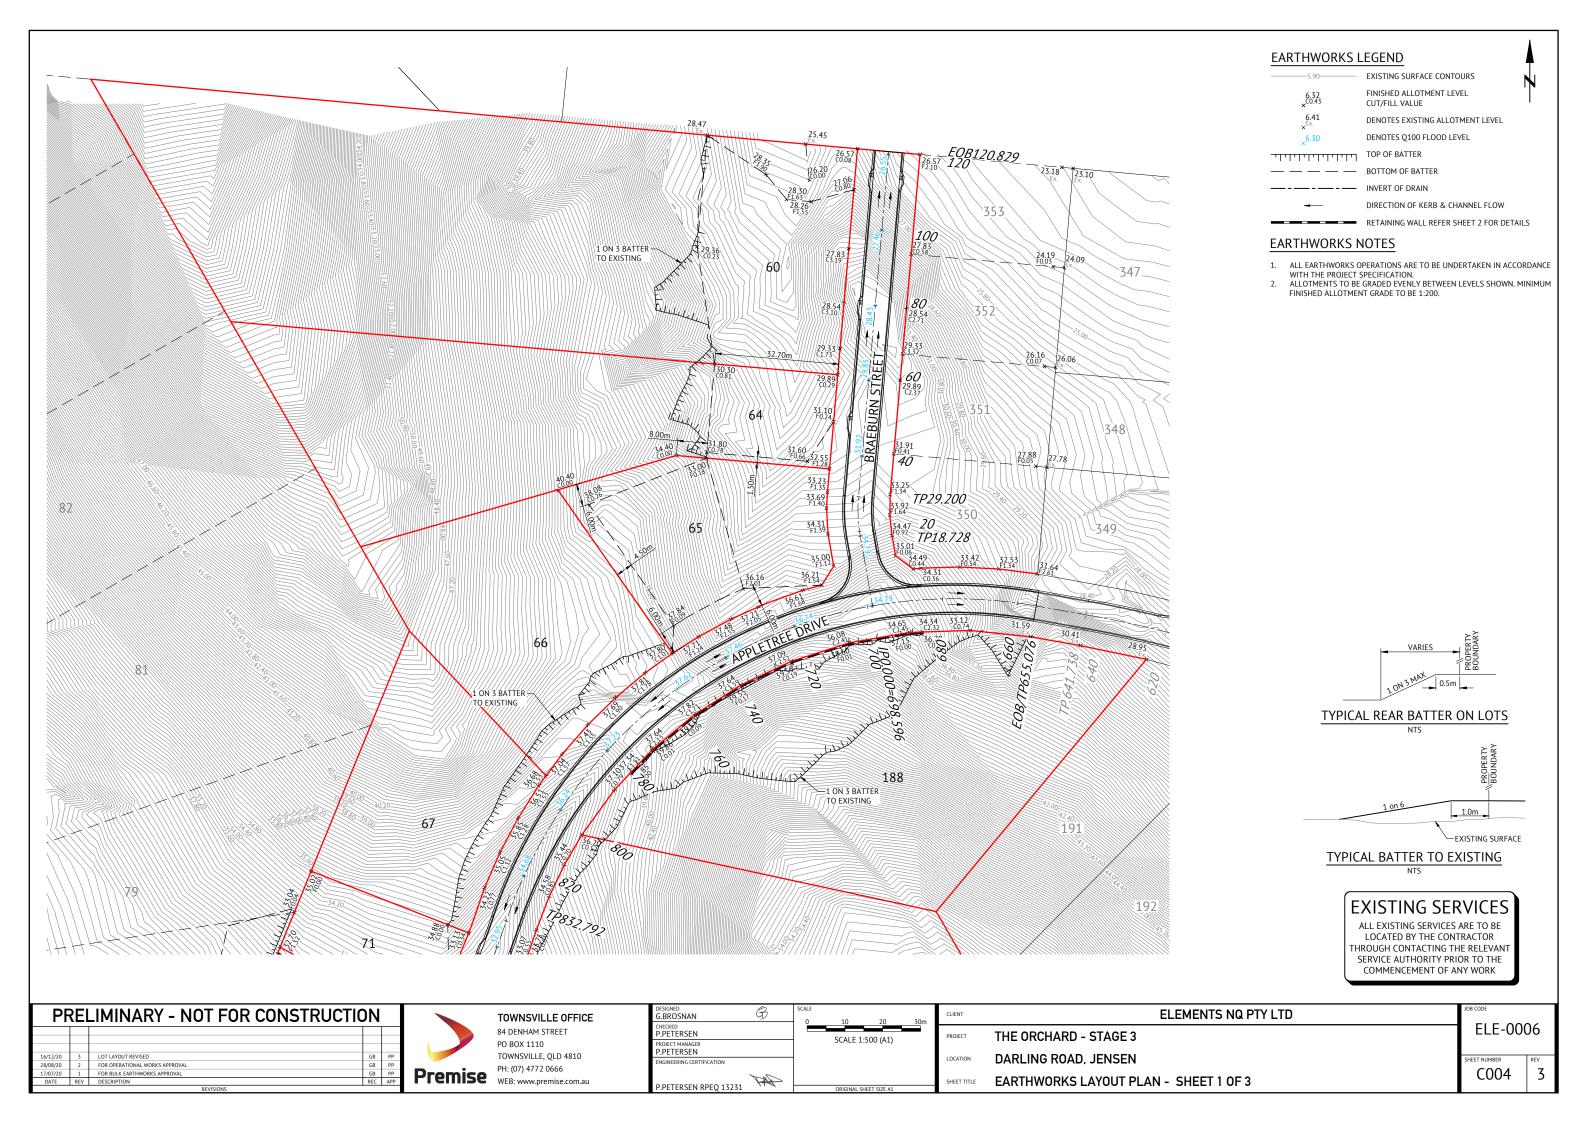

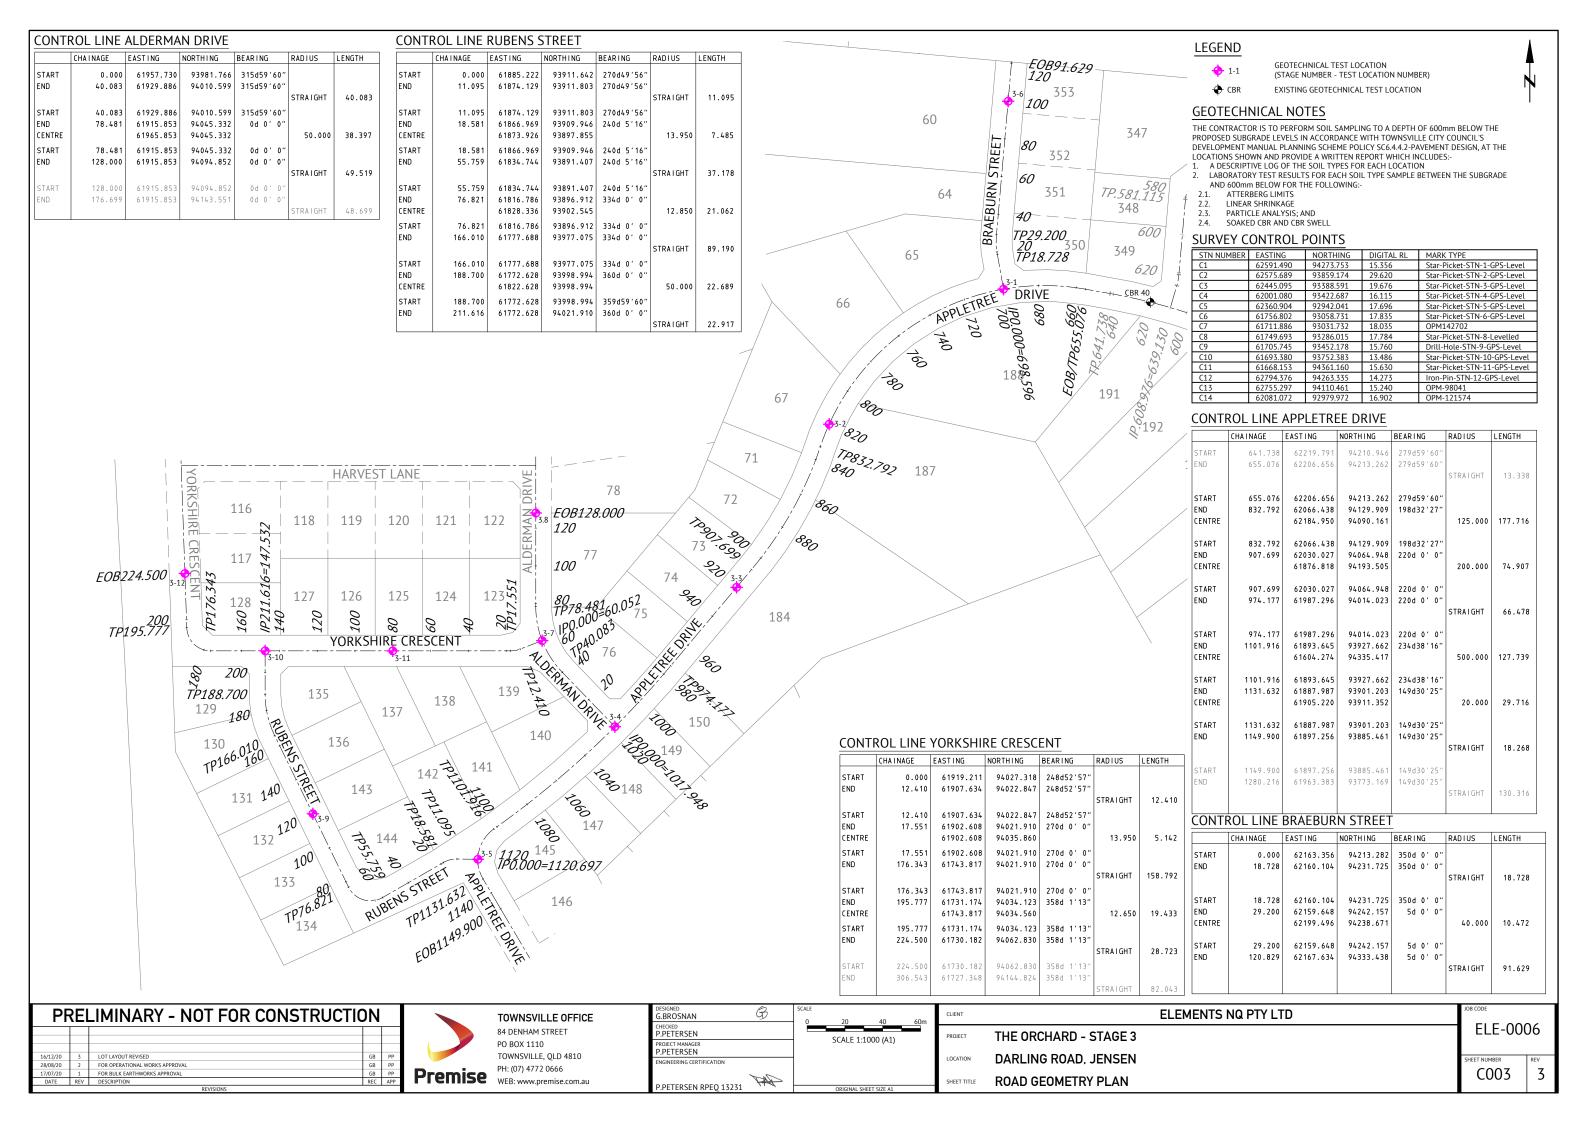

DESIGN HAZARD SCHEDULE

ITEM	DESIGN HAZARD	POTENTIAL HAZARD	RISK	RISK ELIMINATION / MINIMISATION OF HAZARD / RISK	
D1	EMBANKMENT AND SLOPE STABILITY HAZARD	ALLOTMENTS HAVE BEEN BENCHED FOR HOUSE PADS WHICH HAVE CREATED STEEP EMBANKMENTS WHICH WILL HAVE A LONG TERM SLOPE STABLITY ISSUE AND THE EMBANKMENTS ARE GREATER THAN 1M HIGH.	NKMENTS WHICH WILL HAVE A LONG A REJAINING WALL IS TO BE CONSTRUCTED ALONG THE BOUNDARY TO ELI		MODERATE
D2	EXISTING UNDERGROUND / OVERHEAD SERVICES HAZARD	EXISTING UNDERGROUND AND/OR OVERHEAD SERVICES HAZARD EXIST ON SITE.	HIGH THE DESIGN OF THE STRUCTURE HAS ACCOUNTED FOR THE RELOCATION OF THESE EXIST SERVICES AND THE CONTRACTOR IS TO BE MADE AWARE OF THESE EXISTING SERVICES AN TAKE ALL ACTIONS NECESSARY TO MITIGATE THIS HAZARD DURING CONSTRUCTION.		MODERATE
D3	DEEP EXCAVATION HAZARD	DEEP EXCAVATION IS REQUIRED TO INSTALL SEWER TO SERVICE STRUCTURE.	HIGH	THE DEEP EXCAVATION HAZARD CANNOT BE AVOIDED AND THE CONTRACTOR WILL NEED TO TAKE ALL ACTIONS NECESSARY TO ADDRESS THIS HAZARD DURING CONSTRUCTION.	MODERATE

CONSTRUCTION HAZARD SCHEDULE

ITEM	POTENTIAL HAZARD	POSSIBLE PREVENTATIVE ACTION	
C1	C1 DEEP EXCAVATION HAZARD ALL STEPS MUST BE TAKEN TO OBTAIN CURRENT UNDERGROUND SERVICES INFORMATION BEFORE EXCAVATION WORKS COMMENCE. EXCAVATION WORK MUST BE UNDERTAKEN BY APPROINT EXPERIENCED AND QUALIFIED PERSONNEL. EXCAVATIONS SHALL BE ADEQUATELY SHORED AND APPROPRIATE BARRICADES AND SIGNAGE ERECTED, IF REQUIRED.		
C2 OVERHEAD POWER HAZARD WARNING SIGNS AND MARKERS SHALL BE ERECTED ADVISING OF THE PRESENCE OF LIVE OVERHEAD CABLES. A REPRESENTATIVE OF THE SUPPLY AUTHORITY SHALL REMAIN ON SITE DURING EARTHWORKS AND ANY OTHER HIGH RISK WORKS, IF REQUIRED.		WARNING SIGNS AND MARKERS SHALL BE ERECTED ADVISING OF THE PRESENCE OF LIVE OVERHEAD CABLES. A REPRESENTATIVE OF THE SUPPLY AUTHORITY SHALL REMAIN ON SITE DURING EARTHWORKS AND ANY OTHER HIGH RISK WORKS, IF REQUIRED.	
UNDERGROUND ELECTRICAL, TELECOMMUNICATION, GAS AND WATER MAIN HAZARD WARNING SIGNS AND MARKERS SHALL BE ERECTED ADVISING OF THE PRESENCE OF THE EXISTING SERVICE. THE SERVICE SHALL BE IDENTIFIED AND MARKED BY THE SUPPLY AUTHORITY SHALL REMAIN ON SITE DURING THE EXCAVATION WORK, IF REQUIRED.		WARNING SIGNS AND MARKERS SHALL BE ERECTED ADVISING OF THE PRESENCE OF THE EXISTING SERVICE. THE SERVICE SHALL BE IDENTIFIED AND MARKED BY THE SUPPLY AUTHORITY PRIOR TO THE COMMENCEMENT OF EXCAVATION. A REPRESENTATIVE OF THE SUPPLY AUTHORITY SHALL REMAIN ON SITE DURING THE EXCAVATION WORK, IF REQUIRED.	
C4	C4 DEMOLITION AND CLEARING HAZARD SUITABLE QUALIFIED AND EXPERIENCED PERSONNEL SHALL BE RESPONSIBLE FOR THE DEMOLITION AND CLEARING WORKS FOR THE PROJECT AT ALL TIMES. THE CONTRACTORS WORK METHOD STATEMENT SHALL ALSO GIVE CONSIDERATION TO FALLING DEBRIS, COLLAPSE AND DANGEROUS AIRBORNE AGENTS.		
		SUITABLE QUALIFIED AND EXPERIENCED PERSONNEL SHALL BE RESPONSIBLE FOR THE SAFE AND ORDERLY PASSAGE OF VEHICULAR AND PEDESTRIAN TRAFFIC THROUGH THE PROJECT AT ALL TIMES. THE CONTRACTOR SHALL DEVELOP A TRAFFIC MANAGEMENT PLAN (TMP) FOR THE PROJECT TO ESTABLISH APPROPRIATE CONTROLS IN ACCORDANCE WITH THE MANUAL FOR UNIFORM TRAFFIC CONTROL.	
C6 POTENTIAL ROCK FALL LAND ABOVE THE SITE HAS BEEN CLEARED AND SOME EARTHWORKS HAS BEEN UNDERTAKEN CREATING A POTENTIAL ROCK FALL HAZARD. SUITABLE PERSONNEL SHALL BE RESPONSIBLE IDENTIFYING ANY POTENTIAL HAZARD AND THE CONTRACTOR SHALL TAKE APPROPRIATE ACTION TO ELIMINATE THE HAZARD.			

DESIGN HAZARD NOTES:

- 1. PREMISE AUSTRALIA PTY LTD (PREMISE), HAVING BEEN COMMISSIONED TO CARRY OUT DETAILED DESIGN AND DOCUMENTATION OF THESE WORKS, CONFIRM THAT THE PREMISE DRAWING SET HAS BEEN INTERNALLY REVIEWED FOR DESIGN SAFETY IN ACCORDANCE WITH SECTION 22 OF THE WORK HEALTH AND SAFETY ACT 2011 QLD.
- 2. THIS REPORT SUMMARISES AN INTERNAL REVIEW OF THE PREMISE DETAILED DESIGN DRAWINGS FOR DESIGN SAFETY.
 3. THIS REPORT IN NO WAY RELIEVES THE PRINCIPAL, CONTRACTOR OR ANY OTHER PARTY OF THEIR OWN OBLIGATIONS AND RESPONSIBILITIES UNDER THE WORK HEALTH AND SAFETY ACT 2011 QLD, INCLUDING (BUT NOT LIMITED TO) CONSULTATION WITH THE DESIGNER UNDER SECTION 294 OF THE ACT, THE PREPARATION OF SATISFACTORY SAFE WORK METHOD STATEMENTS AND DUTIES OF CARE.
- 4. IT IS A REQUIREMENT UNDER SECTION 296 OF THE WORK HEALTH AND SAFETY ACT 2011 QLD, THAT A COPY OF THIS REPORT BE PROVIDED TO THE CONTRACTOR BY THE ENTITY COMMISSIONING THE WORK SHOWN ON THE PREMISE DRAWINGS.
- 5. AS PER THE DEPARTMENT OF JUSTICE AND THE ATTORNEY-GENERAL- WORKPLACE HEALTH AND SAFETY QUEENSLAND, A WRITTEN REPORT IS NOT REQUIRED FOR DESIGNS THAT HAVE TYPICAL FEATURES.

CONSTRUCTION HAZARD NOTES:

- 1. UNDER THE QUEENSLAND WORK HEALTH AND SAFETY ACT 2011, THE WORK HEALTH AND SAFETY REGULATION 2011 AND OTHER LEGISLATION AND GUIDELINES, THE PRINCIPAL CONTRACTOR HAS SPECIFIC OBLIGATIONS IN RELATION TO THE SAFE OPERATION OF THE SITE AND OF THE WORKS.
 TO ASSIST THE PRINCIPAL CONTRACTOR IN COMPLYING WITH THESE OBLIGATIONS THE PROJECT DESIGNERS HAVE IDENTIFIED BY DRAWING NOTES, AREAS WHERE POTENTIAL HAZARDS MAY ARISE. THESE NOTES OR ADVICE, SHALL NOT NECESSARILY BE CONSIDERED COMPLETE AND ARE BASED UPON THE DESIGNERS' UNDERSTANDING OF THE SAFETY RISKS ASSOCIATED WITH THE WORKS.
- THESE NOTES OR ADVICE SHALL NOT RELIEVE THE PRINCIPAL CONTRACTOR OF ANY OBLIGATION UNDER THE RELEVANT LEGISLATION OR GUIDELINE. THE PRINCIPAL CONTRACTOR SHALL REMAIN RESPONSIBLE FOR THE PREPARATION OF AN APPROPRIATE WORK HEALTH SAFETY MANAGEMENT PLAN
- 2. PURSUANT TO THE WORK HEALTH AND SAFETY ACT 2011 WE HEREBY ADVISE THAT OUR DESIGN SAFETY REVIEW HAS IDENTIFIED UNUSUAL OR ATYPICAL DESIGN FEATURES THAT MAY PRESENT ADDITIONAL HAZARDS OR RISKS DURING THE CONSTRUCTION PHASE AND THESE ARE LISTED IN THE CONSTRUCTION HAZARD SCHEDULE.

CONSEQUENCE TABLE

LEVEL	LEVEL CONSEQUENCE		
5 - CATASTROPHIC	FATALITY OR MULTIPLE PERSONS ONSITE WITH LIFE THREATENING HEALTH EFFECTS OR INABILITY TO CONTINUE	HUGE FINANCIAL OR TIME LOSS	
4 - MAJOR	EXTENSIVE INJURIES, OR ONSET OF SEVERE OR LIFE THREATENING HEALTH EFFECTS TO SINGLE PERSON ONSITE. MULTIPLE PERSONS WITH ONSET OF IRREVERSIBLE HEALTH EFFECTS. PERMANENT INJURY TO PERSON ONSITE.	MAJOR FINANCIAL OR TIME LOSS	
3 - MODERATE	MEDICAL TREATMENT REQUIRED. IRREVERSIBLE HEALTH EFFECT TO A SINGLE PERSON. MULTIPLE PERSONS ONSITE WITH REVERSIBLE HEALTH EFFECTS.	HIGH FINANCIAL OR TIME LOSS	
2 - MINOR	FIRST AID, SINGLE OR MULTIPLE INJURIES AMONGST PERSONS ONSITE. SINGLE PERSON ONSITE WITH MODERATE SHORT TERM REVERSIBLE HEALTH EFFECTS.	MEDIUM FINANCIAL OR TIME LOSS	
1 - INSIGNIFICANT	NO INJURIES. OVER EXPOSURE TO A SINGLE PERSON ONSITE, BUT NO REPORTED HEALTH EFFECTS.	LOW FINANCIAL OR TIME LOSS	

LIKELIHOOD TABLE

LEVEL	DESCRIPTION	QUANTIFICATION GUIDE
A - ALMOST CERTAIN	THE EVENT IS EXPECTED TO OCCUR IN MOST CERTAIN CIRCUMSTANCES	MORE THAN ONCE PER YEAR
B - LIKELY	THE EVENT <u>WILL</u> PROBABLY OCCUR IN MOST CIRCUMSTANCES	AT LEAST ONCE IN 5 YEARS
C - POSSIBLE	THE EVENT <u>SHOULD</u> OCCUR AT SOME TIME	AT LEAST ONCE IN 10 YEARS
D - UNLIKELY	THE EVENT <u>COULD</u> OCCUR AT SOME TIME	AT LEAST ONCE IN 30 YEARS
E - RARE	THE EVENT MAY OCCUR IN EXCEPTIONAL CIRCUMSTANCES	LESS THAN ONCE IN 30 YEARS

RISK ANALYSIS MATRIX

				CONSEQUENCE		
		1 - INSIGNIFICANT	2 - MINOR	3 - MODERATE	4 - MAJOR	5 - CATASTROPHIC
	A - ALMOST CERTAIN	MODERATE	HIGH	EXTREME	EXTREME	EXTREME
HOOD	B - LIKELY	MODERATE	HIGH	HIGH	EXTREME	EXTREME
	C - POSSIBLE	LOW	MODERATE	HIGH	EXTREME	EXTREME
LIKE	D - UNLIKELY	LOW	LOW	MODERATE	HIGH	EXTREME
	E - RARE	LOW	LOW	MODERATE	HIGH	HIGH

RISK EVALUATION TABLE

RISK LEVEL		ACTION REQUIRED			
	EXTREME	UNACCEPTABLE RISK. RE-DESIGN REQUIRED. DO NOT PROCEED WITHOUT ADDITIONAL CONTROLS.			
	HIGH	UNACCEPTABLE RISK. ADDITIONAL CONTROLS NEEDED. CONSIDER FURTHER REVIEW AND CONSIDER RE-DESIGN			
	MODERATE	RISK MAY BE ACCEPTABLE. MANAGEMENT TO DETERMINE ACTIONS REQUIRED			
	LOW	ACCEPTABLE. MANAGE RISK THROUGH ROUTINE PROCEDURES AND OTHER ADMINISTRATIVE CONTROLS			

PRELIMINARY - NOT FOR CONSTRUCTION FOR OPERATIONAL WORKS APPROVA



TOWNSVILLE OFFICE 84 DENHAM STREET TOWNSVILLE, QLD 4810 PH: (07) 4772 0666

DESIGNED G.BROSNAN	9	SCALE
CHECKED P.PETERSEN		
PROJECT MANAGER P.PETERSEN		
ENGINEERING CERTIFICATION	TAF	
P.PETERSEN RPEQ 13231		ORIGINAL SHEET SIZE A1

ELEMENTS NQ PTY LTD THE ORCHARD - STAGE 3 DARLING ROAD, JENSEN SAFETY IN DESIGN REPORT

ELE-0006

C002

